

UPFIT FOR THE CITY OF CONCORD TRANSPORTATION DEPT. 242 GENERAL SERVICES DR SM, CONCORD, NC 28025

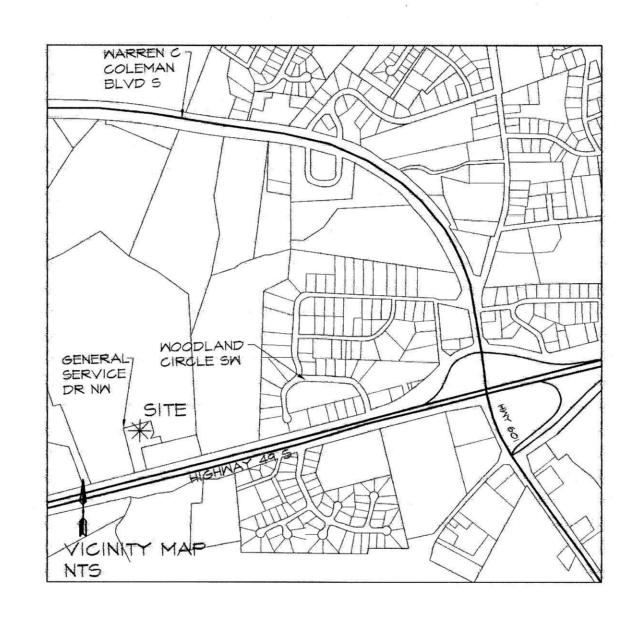

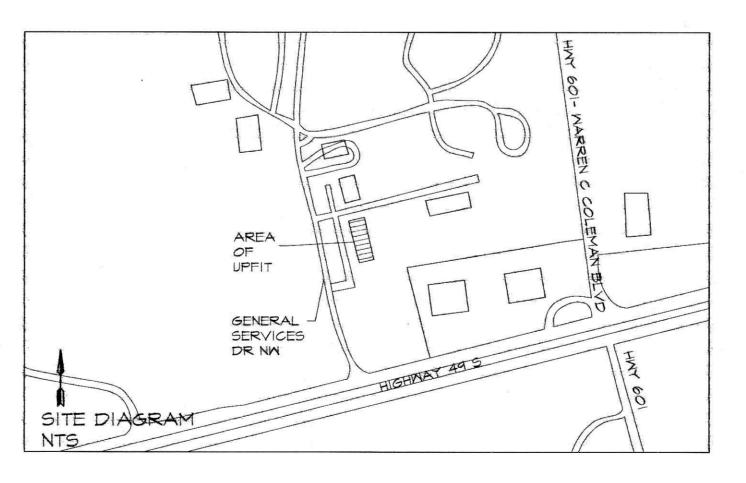

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THE CARD.

ARCHITE

2 CHURCH ST. N. CONCORD, NC 28C

1-104.188.8333 F-104.182.0481

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SERVICES DR SN, CONC

TODAY'S DATE: 09.10.2021
SCHEMATIC DESIGN APPR: XXX
ORIGINAL SEAL DATE: XXX

REVISIONS:

DRAWING #: 210805 CVR
DRAWN BY: RGW
PROJECT MGR: VLM
CHECKED BY: V. MOORE



SPACE A	SPACE B	SPACE C	
OFFICE BUSINESS (B)	OFFICE BUSINESS (B)	SHOP FACTORY (F-I) \$ STORAGE (S-I)	
OCCUPAN	KY DIAGRAM .	NO SCALE	
	BUSINESS (B)	BUSINESS (B) (B)	OFFICE OFFICE (F-I) BUSINESS (B) STORAGE

BUILDING CODE SUMMARY

OWNED BY:	CITY / COUNTY	PRIVATE	STATE	
CODE ENFORCEMENT JURISDICTION 🔯	NTY .	COUNTY	STATE	
LEAD DESIGN PROFESSIONAL: DESIGNER FIRM NAME ARCHITECTURAL CARLOS MOORE ARCH. P.	VIRGINIA L N NAME A VIRGINIA L	LICENSE #	TELEPHONE # 104-188-8383	EMAIL: VMOORE@CMOOREARCH,
CIVIL	GREG R	IFFE 16396	704-721-6449	GREGOGARENGINEERING.C
FIRE ALARM GAR ENGINEERING PLUMBING GAR ENGINEERING	GREG R		704-721-6449	GREGOGARENGINEERING.C
MECHANICAL GAR ENGINEERING Sprinkler-Standpipe GAR ENGINEERING	GREG R	IFFE 16396	704-721-6449 704-721-6449	GREGOGARENGINEERING C
STRUCTURAL	Total Marketine a		Terror to the stage of the contract of the	
Other				
2018 NC BUILDING CODE FOR:	NEW BUILD		Ø RE	ENOVATION
		NTERIOR COMPLETION		
	ADDITION	RE- CONTACT THE LOCAL AL PROCEDURES AND REC	RUIREMENTS	
		CONSTRUCTION- SHELL/CORTION FOR POSSIBLE ADDIT		
2018 NC EXISTING CODE: EXISTING:	PRESCRIP	TIVE REPAIR	2	CHAPTER 14
	LEVEL I	☐ LEVEL	H	LEVEL III
	HISTORIC	PROPERTY		CHANGE OF USE
CONSTRUCTED: (DATE)	CURRI	ENT OCCUPANCY (S) (CH. 3). OFFICE(B)	-
RENOVATED: (DATE)	PROP	OSED OCCUPANCY (S) (CH	3): BUSINESS (B)/	STORAGE (S-I)/ FACTORY (F-
RISK CATEGORY (TABLE 1604.5): CUI	RRENT:] 14	
	PROPOSED:] IV	
BUILDING DATA	1200			
Construction Type: I-A II-A II-B II-B		□ IV □ V-A ⊠ V-B		
		M 4-5		
SPRINKLERS: NO PARTIAL	✓ YES	□NFPA I3 □ NFPA	ISR NFPA	13D
The state of the s	CLASS []			
Fire District: 🛛 NO 🔲 YES SPECIAL INSPECTIONS REQUIRED: 🖾 NO	FLOOD HAZARI		YES	RISDICTION FOR
	L 1123	ADDITIONAL PROCEDU	RES AND REQUI	REMENTS)
Building Height: Feet 25'+/- RIDGE MEZZANINE: NO X YES GROSS BUILDING AREA:				
FLOOR EXISTING SF				
6TH FLOOR		NEW SF	SUB-TOTAL	
5TH FLOOR		NEM SF	SUB-TOTAL	
5TH FLOOR 4TH FLOOR 3RD FLOOR 2ND FLOOR		NEM SF		
5TH FLOOR		NEM SF	0 SF +/- 7,550 SF +	
5TH FLOOR 4TH FLOOR 3RD FLOOR 2ND FLOOR MEZZANINE IST FLOOR BASEMENT		NEM SF	0 SF +/-	/-
5TH FLOOR 4TH FLOOR 3RD FLOOR 2ND FLOOR MEZZANINE IST FLOOR BASEMENT TOTAL: 7,550 SF +/-	LLOWABLE ARI	EA:	0 SF +/- 7,550 SF + 7,550 SF +	/-
5TH FLOOR 4TH FLOOR 4TH FLOOR 3RD FLOOR 2ND FLOOR MEZZANINE IST FLOOR BASEMENT TOTAL: 7,550 SF +/- A PRIMARY OCCUPANCY: ASSEMBLY	LLOMABLE ARI	EA: A-2	0 SF +/- 7,550 SF + 7,550 SF +	/- /-
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5TH FLOOR 4TH FLOOR 4TH FLOOR 3RD FLOOR 2ND FLOOR MEZZANINE IST FLOOR BASEMENT TOTAL: 7,550 SF +/- A PRIMARY OCCUPANCY: ASSEMBLY BUSINESS	LLOMABLE ARI	EA: A-2	0 SF +/- 7,550 SF + 7,550 SF + 1,550 SF +	/- /-
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STH FLOOR 4TH FLOOR 3RD FLOOR 2ND FLOOR MEZZANINE BASEMENT TOTAL: DESCRIPTION BUSINESS DEDUCATIONAL HAZARDOUS H-I DETONAT INSTITUTIONAL I-I I-2 I-3 CONDITION MERCANTILE RESIDENTIAL STORAGE S-I MODERAT UTILITY & MISCELLANEOUS ACCESSORY OCCUPANCY CLASSIFICATION NCIDENTAL USES (TABLE 509):	LLOWABLE ARI A-1 A E H-2 DEFL 1-3 1-4 1	EA: A-2	0 SF +/- 7,550 SF + 7,550 SF + A-5 ERATE	/- /- >W] H-5 HPM
STH FLOOR 4TH FLOOR 3RD FLOOR 2ND FLOOR MEZZANINE IST FLOOR BASEMENT TOTAL: DESCRIPTION BUSINESS DEDUCATIONAL HAZARDOUS H-I DETONAT INSTITUTIONAL I-I DETONAT INSTITUTIONAL RESIDENTIAL STORAGE S-I MODERAT UTILITY & MISCELLANEOUS ACCESSORY OCCUPANCY CLASSIFIC NCIDENTAL USES (CHAPTER 4 - LIST COMPANY) SPECIAL USES (CHAPTER 4 - LIST COMPANY) SPECIAL USES (CHAPTER 4 - LIST COMPANY)	LLOWABLE ARI A-1 A E H-2 DEFL 1-3 1-4 1	EA: A-2	0 SF +/- 7,550 SF + 7,550 SF + A-5 ERATE	/- /- >W] H-5 HPM
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STH FLOOR 4TH FLOOR 3RD FLOOR 2ND FLOOR 2ND FLOOR MEZZANINE IST FLOOR BASEMENT TOTAL: PRIMARY OCCUPANCY: ASSEMBLY BUSINESS EDUCATIONAL HAZARDOUS H-I DETONAT INSTITUTIONAL I-I I-2 I-3 CONDITION MERCANTILE RESIDENTIAL STORAGE S-I MODERAT UTILITY & MISCELLANEOUS INCIDENTAL USES (TABLE 509): SPECIAL USES (CHAPTER 4 - LIST COMPANDED SEPECIAL PROVISIONS: (CHAPTER 5) MIXED OCCUPANCY: NO YES SEPECIAL USE SEPARATION (5)	LLOWABLE ARI A-I A-I E H-2 DEFL I -3 I-4 I	EA: A-2	0 SF +/- 7,550 SF + 1,550 SF +	/- /- >W] H-5 HPM
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STH FLOOR 4TH FLOOR 3PD FLOOR 2ND FLOOR MEZZANINE IST FLOOR BASEMENT TOTAL: BUSINESS	LLOWABLE ARI A-1 A E H-2 DEFL 1-3 1-4 2 R-1 TE S-2 LOW CATION (S): ODE SECTION - LIST CODE EPARATION: 08.2.5) T AS A NON-S struction for the api so determined 8.4) - See bel of the occupant ivided by the contact Area of Occupant	EA: A-2 A-3 A-4 FACTORY F-1 MODING AGRATE H-3 COMBUST 3 4 5 R-2 R-3 R-4 HIGH-PILED ARAGE OPEN ENCLO NS): SECTIONS): HR. EXCEPTION: SEPARATED USE (SEE EXC The building shall be determined by the entire of the entire o	OSF +/- T,550 SF + T,550 SF + T,550 SF + A-5 ERATE F-2 LO N/A N/A EPTIONS.) Initial by applying the entire building building. In of the ratios of each use shall no	the height. The most:
SRD FLOOR 2ND FLOOR MEZZANINE IST FLOOR BASEMENT TOTAL: T550 SF +/- PRIMARY OCCUPANCY: ASSEMBLY BUSINESS EDUCATIONAL HAZARDOUS H-I DETONAT INSTITUTIONAL I-I I-2 I-3 CONDITION MERCANTILE RESIDENTIAL STORAGE S-I MODERAT UTILITY & MISCELLANEOUS ACCESSORY OCCUPANCY CLASSIFICATION INCIDENTAL USES (TABLE 509): SPECIAL USES (CHAPTER 4 - LIST OF SEPECIAL PROVISIONS: (CHAPTER 5) MIXED OCCUPANCY: NO YES SEE INCIDENTAL USE SEPARATION (5) THIS SEPARATION IS NOT EXEMP NON-SEPARATED USE (508.3) The required type of construction, Separated Mixed Occupancy (50 For each story, the area floor area of each use of Actual Area of Occupancy A Allowed Area Occupancy A Allowed Allowed	LLOWABLE ARE LA-I A-I E H-2 DEFL I-3 I-4 I PARKING GA CATION (S): ODE SECTION - LIST CODE EPARATION OB.2.5) T AS A NON-S Setruction for the application of the application for the application for the application of the application of the application of the application for the application of the application for the application for the application of the application for the application of the applicat	EA: A-2	OSF +/- T,550 SF + T,550 SF + T,550 SF + A-5 ERATE F-2 LO N/A N/A EPTIONS.) Initial by applying the entire building building. In of the ratios of each use shall no	the height. The most

ORY NO.	DESCRIPTION AND USE	(A) BLDG AREA PER STORY (ACTUAL)	(B) TABLE 506.2 ⁴ AREA	(C) AREA FOR FRONTAGE INCREASE ¹⁵	(D) ALLOWABLE AREA PER STORY OR UNLIMITED ^{2,3}
T FLOOR	BUSINESS (B)	5,448 SF	36,000	NA	36,000
CHANICAL PLATFORM	MECHANICAL	613 SF	36,000	NA	36,000
T FLOOR	STORAGE (S-I)	1,489 SF	34,000	N/A	34,000
T FLOOR	FACTORY (F-1)	613 SF	36,000	N/A	36,000

1. Open space area increase from Section 5063 are computed thus:

- a. Perimeter which fronts a public way or open space having 20 feet minimum width = ____ (F)
- b. Total Building Perimeter
- c. Ratio (F/P) = _____ (F/P)
- d. M= Minimum width of public way = ____(M)
- e. Percent of frontage increase $I = 100 (F/P 0.25) \times W/30 = ____(%)$
- 2. Unlimited area applicable under conditions of Sections 507

- 3. Maximum Building Area = TOTAL NUMBER OF STORIES IN THE BUILDING X D (MAXIMUM 3 STORIES) (506.2)
- 4. The maximum area of OPEN parking garages must comply with 406.5.4 5. FRONTAGE INCREASE IS BASED ON THE UNSPRINKLERED
- AREA VALUE IN TABLE 506.2

ALLOWABLE HEIGHT

	ALLOWABLE	SHOWN ON PLANS	CODE REFERENCE
BUILDING HT IN FEET (TABLE 504.3)	60'-0"	25'-0" +/-	NCSBC 504.3
BUILDING HT IN STORIES (TABLE 504.4)	2	1	NCSBC 504.3

- I. PROVIDE CODE REFERENCE IF THE "SHOWN ON PLANS" QUANITY IS NOT BASED ON TABLE 504.3 OR 504.4.
- 2. THE MAXIMUM HEIGHT OF AIR TRAFFIC CONTROL TOWERS MUST COMPLY WITH TABLE
- 3. THE MAXIMUM HEIGHT OF OPEN PARKING GARAGES MUST COMPLY WITH TABLE 406.5.4.

FIRE PROTECTION REQUIREMENTS

LIFE SAFETY PLAN SHEET #, IF PROVIDED

Rating	Fire			Rating	Detail #	UL Design #	Design #	Design #
0.2	Separation Distance (Feet) Req'd Provided (M' * Reduction) \$ Sheet #		4	For Rated Assembly	For Rated Penetration	For Rated Joints		
Structural frame, ncluding columns, girders, trusses			0					
Bearing walls	Los Nathana	· ·	0	mayor to Comba and one				Van Barrera Van een I
Exterior	TOPE TO STATE AND	e contract	0					
North	0		0					
East			0					
West	0		0					
South	0		0					
Interior			0	277				
Nonbearing walls and partitions			N/A					
Exterior		77.	N/A					
North			0					
East			0					
West			0		5			
South			0					
Interior walls \$ partitions	0		0					
Floor construction including supporting beams and joists			0					
Roof construction including supporting beams and joists			0					
Shafts Enclosures -	Exit		NA					2 2 2 2 3 3 3 3 4 1 1 1 1 1 1 1 1 1 1 1 1 1 1 1
Shaft Enclosures - C	Other		NA					
Corridor Separation	1		NA					
Occupancy Separati			NA					
Party/Fire Wall Sept			NA					
Smoke Barrier Sepa			NA					
Tenant Separation			NA			14,		
Incidental Use Separ	cation	a vent	NA					

PERCENTAGE OF WALL OPENING CALCULATIONS

N/A	DEGREE OF OPENINGS PROTECTION (TABLE 105.8)	ALLOWABLE AREA %	ACTUAL SHOWN ON PLANS %
ALL SIDES GREATER THAN 30'	UP, NS	25%	< II%

LIFE SAFETY SYSTEM REQUIREMENTS

□ NO	₩ YES
□ NO	YES
□ NO	YES
₩ NO	YES PARTIA
□ NO	YES
	NO NO NO NO NO NO N

LIFE SAFETY PLAN REQUIREMENTS

- FIRE AND/ OR SMOKE RATED WALL LOCATIONS (CHAPTER 1)
- ASSUMED AND REAL PROPERTY LINE LOCATIONS (IF NOT ON THE SITE PLAN)
- EXTERIOR WALL OPENING AREA WITH RESPECT TO DISTANCE TO ASSUMED PROPERTY LINES (105.8)
- OCCUPANCY USE FOR EACH AREA AS IT RELATES TO OCCUPANT LOAD CALCULATION (TABLE 1004.1.2) OCCUPANT LOADS FOR EACH AREA
- EXIT ACCESS TRAVEL DISTANCES (1017)
- COMMON PATH OF TRAVEL DISTANCES (TABLES 1006.2.1 \$ 1006.3.2(1))
- DEAD END LENGTHS (1020.4)
- CLEAR EXIT WIDTHS FOR EACH DOOR
- MAXIMUM CALCULATED OCCUPANT LOAD CAPACITY EACH EXIT DOOR CAN ACCOMMODATE BASED ON
- ACTUAL OCCUPANT LOAD FOR EACH EXIT DOOR
- A SEPARATE SCHEMATIC PLAN INDICATING WHERE FIRE RATED FLOOR/CEILING/AND OR ROOF STRUCTURE IS PROVIDED FOR PURPOSES OF OCCUPANCY SEPARATION
- LOCATION OF DOORS WITH PANIC HARDWARE (1010.1.9.9)
- LOCATION OF DOORS WITH DELAYED EGRESS LOCKS AND THE AMOUNT OF DELAY (1010.1.9.7)
- LOCATION OF ELECTROMAGNETIC EGRESS LOCKS (1010.1.9.9) LOCATION OF DOORS EQUIPPED WITH HOLD OPEN DEVICES
- LOCATION OF EMERGENCY ESCAPE WINDOWS (1030)
- THE SQUARE FOOTAGE OF EACH FIRE AREA (202)
- THE SQUARE FOOTAGE OF EACH SMOKE COMPARTMENT FOR OCCUPANCY CLASSIFICATION 1-2 (407.5)(407.4)
- NOTE ANY CODE EXCEPTIONS OR TABLE NOTES THAT MAY HAVE BEEN UTILIZED REGARDING THE ITEMS ABOVE

ACCESSIBLE DWELLING UNITS (SECTION 1107)

TOTAL UNITS	ACCESSIBLE UNITS REQUIRED	ACCESSIBLE UNITS PROVIDED	TYPE A UNITS REQUIRED	TYPE A UNITS PROVIDED	TYPE B UNITS REQUIRED	TYPE B UNITS PROVIDED	TOTAL ACCESSIBLE UNITS PROVIDED
			N/A				

ACCESSIBLE PARKING

		(SEC	CTION 1106)	2		
LOTOR	TOTAL # OF PA	RKING SPACES	# OF ACCESS	SIBLE SPACES	PROVIDED	TOTAL #
PARKING AREA	REQUIRED	PROVIDED	REGULAR WITH 5	VAN SPA	CES WITH	PROVIDED
			ACCESS AISLE	132" ACCESS AISLE	8' ACCESS AISLE	
EXISTING	×	Х.,,	X	X		×
PROPOSED		1/4	+		Annual transfer and the Annual transfer	e e la companya de la companya del companya de la companya del companya de la com
TOTAL		1 1/				

EXISTING PARKING TO REMAIN: ENSURE ACCESSIBLE ROUTE

PLUMBING FIXTURE REQUIREMENTS (TABLE 2902.1)

				(INDLL .	2-102.17						
USE		MATER	RCLOSETS		URINALS	LA	VATORIES	5	SHOWER /	DRINKING	FOUNTAINS
		MALE	FEMALE	UNISEX		MALE	FEMALE	UNISEX	TUBS	REGULAR	ACCESSIBL
SPACE	EXISTING	0	0	3				4	1	0	1
	NEM	4	5	0	2	4	4	0	0	F	ł
	REQUIRED	2	2	0	0	2	2	0	0	1	1

PLUMBING NOTES:

SPECIAL APPROVALS

Special approval: (Local Jurisdiction, Department of Insurance, SBCCI, ICC, etc., describe below)

ENERGY SUMMARY

ENERGY REQUIREMENTS THE FOLLOWING DATA SHALL BE CONSIDERED MINIMUM AND ANY SPECIAL ATTRIBUTE REQUIRED TO MEET THE ENERGY CODE SHALL ALSO BE PROVIDED. EACH DESIGNER SHALL FURNISH THE REQUIRED PORTION OF THE PROJECT INFORMATION FOR THE PLAN DATA SHEET. IF PERFORMANCE METHOD, STATE THE ANNUAL ENERGY COST FOR THE STANDARD REFERENCE DESIGN VS ANNUAL ENERGY COST FOR THE PROPOSED

EXISTING BUILDING ENVELOPE COMPLIES WITH CODE: | NO | YES THE REMAINDER OF THIS SECTION IS NOT APPLICABLE)


EXEMPT BUILDING: NO YES (PROVIDE CODE OR STATUTORY REFERENCE)

CLIMATE ZONE: 3A 4A 5A

METHOD OF COMPLIANCE: ENERGY CODE | PERFORMANCE | PRESCRIPTIVE ASHRAE 90.1 | PERFORMANCE | PRESCRIPTIVE

(IF "OTHER" SPECIFY SOURCE HERE) Roof/ceiling Assembly (ea. assembly) Exterior Walls (ea. assembly)
Description of assembly Description of assembly N-Value of total assembly
R-Value of total assembly
R-Value of insulation
Openings (windows or doors w/glazing)
U-Value of assembly
shading coefficient U-Value of total assembly. R-Value of total assembly. R-Value of insulation Skylights in each assembly _ U-Value of skylight total square footage of _ lon'e required, if applicable Door R-Values Malls adjacent to unconditioned space (ea. assembly)
Description of assembly _____ Malls below grade (ea. assembly) Description of assembly U-Value of total assembly
R-Value of insulation
Openings (windows or doors w/glazing)
U-Value of assembly
low e required, if applicable
Door R-Values U-Value of total assembly R-Value of insulation Description of assembly Floor over unconditioned space (ea. assembly) U-Value of total assembly R-Value of total assembly R-Value of insulation Description of assembly V-Value of total assembly R-Value of total assembly R-Value of insulation Horizontal/vertical requirement

> NO CHANGE TO THERMAL ENVELOPE

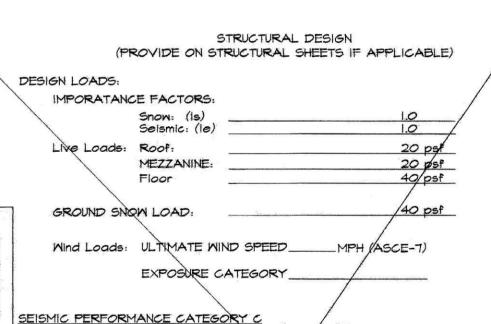

SEISMIC PERFORMANCE CATEGORY C
Compliance with Section 1616.4 only? NO SEISMIC PERFORMANCE CATEGORY B & C Occupancy Group Seismic Design Category Site Classification Basic structural system (check one) Bearing Wall ___ Dual w/Special Moment Frame ___ Building Frame ___ Dual w/Intermediate R/C or Special Steel ___ Moment Frame ___ Inverted Pendulum Response Modification Coefficient R=____ Seismic Response Coefficient Cs= _04___ _____Simplified ____ _ Equivalent Lateral Force ____ Modal Analysis Procedure / Seismic Base Shear / Vx _____ Vy _____ Architectural, Mechanical, Components anchored? __yes_ LATERAL DESIGN GONTROL : Earthquake _____

SOIL BEARING CAPACITIES: Field Test/(Provide copy of test report) ____n/a_ Presumptive Bearing Capacity ______psf Pile size, type, and capacity

ORE ARCHIT CERT. NO. 51212 ORTH CAROLINA

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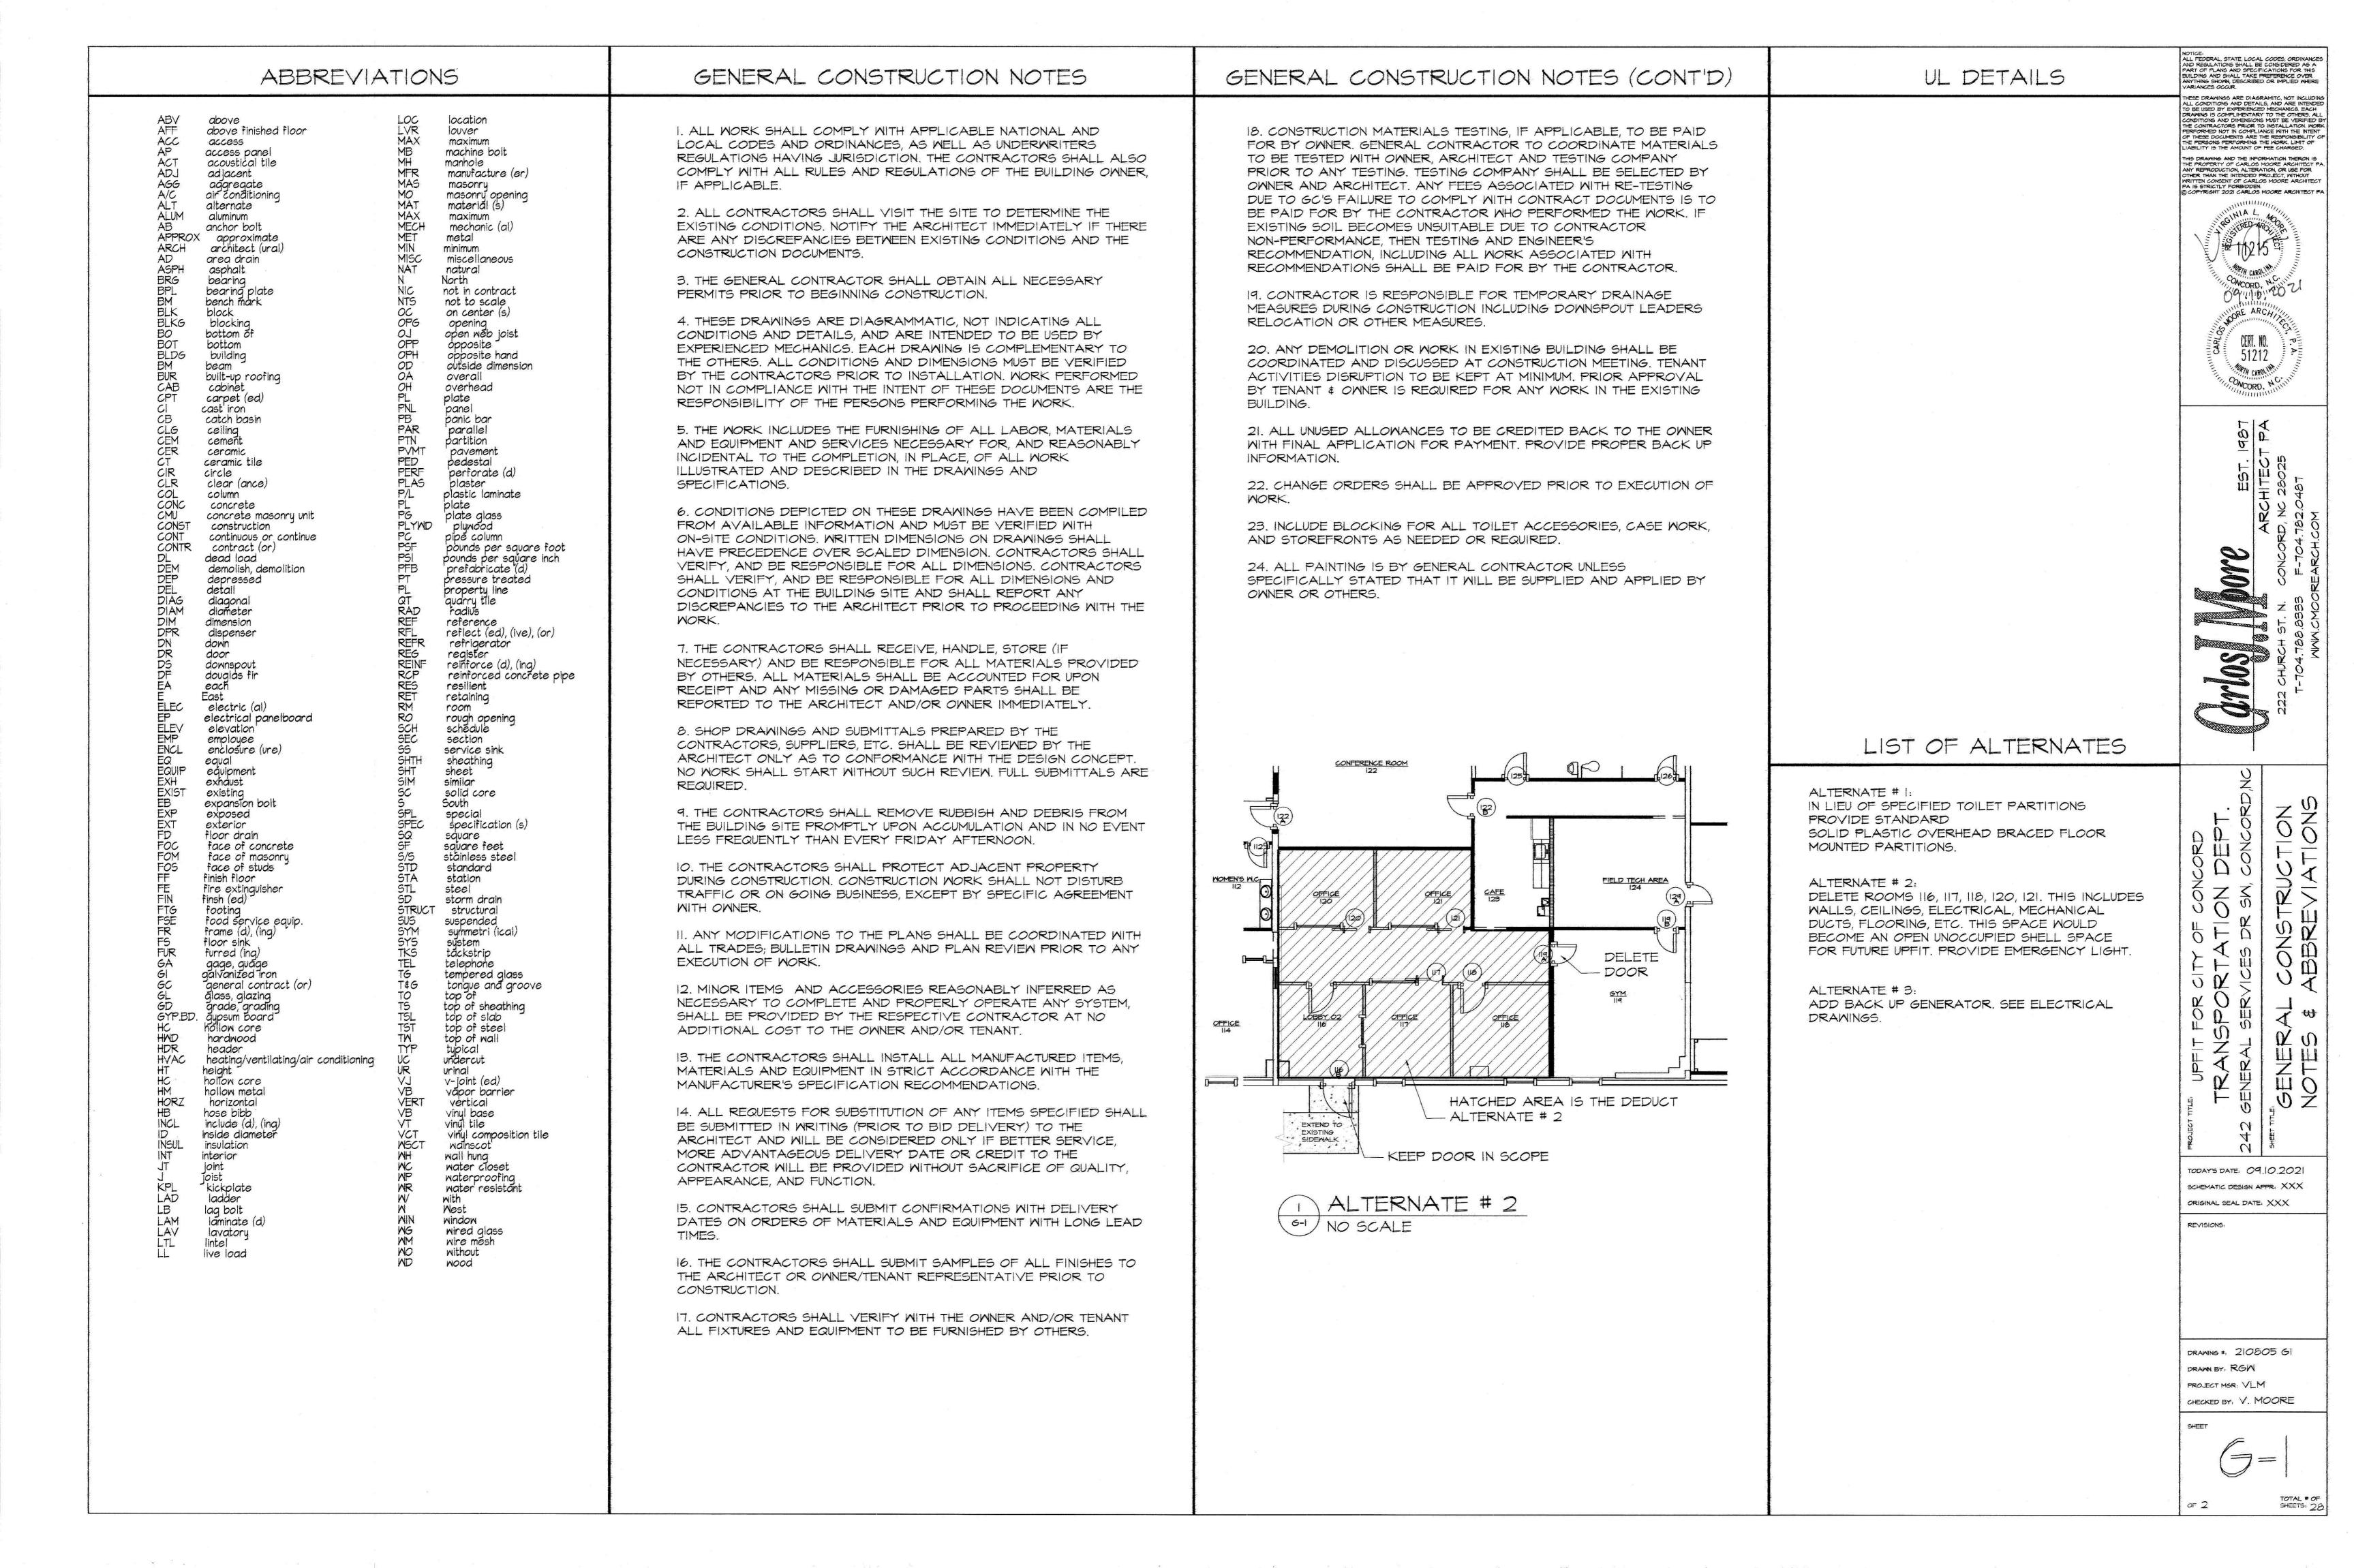
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TODAY'S DATE: 09.10.2021 SCHEMATIC DESIGN APPR: XXX

ORIGINAL SEAL DATE: XXX REVISIONS:

DRAMING #: 2 0805 CR DRAWN BY: RGW PROJECT MGR: VLM CHECKED BY, V. MOORE



CORRIDOR WIDTHS: EVERY CORRIDOR SERVING AN OCCUPANT LOAD OF 10 OR MORE SHALL BE NOT LESS THAN 44 INCHES IN WIDTH. CORRIDORS SERVING AN OCCUPANT LOAD OF LESS SERVING AN OCCUPANT LOAD OF LESS THAN IO SHALL NOT BE LESS THAN 36 INCHES IN WIDTH.

- 2. CORRIDORS OVER 200 FEET: CORRIDORS THAT EXCEED 200 FEET IN LENGTH SHALL HAVE A MINIMUM CLEAR WIDTH OF 60 INCHES; OR HAVE, AT A CENTRAL LOCATION, A 60 INCH MIN. WHEEL-CHAIR TURNING SPACE OR PASSING ALCOVE: OR HAVE, AT A CENTRAL LOCATION, AN INTERVENING CROSS OR TEE CORRIDOR, A MINIMUM OF 44 INCHES IN WIDTH; OR HAVE, AT A CENTRAL LOCATION, AN OPERABLE
- 3. EVERY AISLE SHALL BE NOT LESS THAN 3 FEET WIDE IF SERVING ONLY ONE SIDE, AND NOT LESS THAN 3 FEET 6 INCHES WIDE IF SERVING BOTH SIDES. SUCH MINIMUM WIDTH SHALL BE MEASURED AT THE POINT FARTHEST FROM AN EXIT, CROSS AISLE OR FOYER AND SHALL BE INCREASED BY 1-1/2" FOR EACH 5 FEET IN LENGTH TOWARD THE EXIT, CROSS AISLE OR FOYER. WITH CONTINENTAL SEATING, SIDE AISLES SHALL NOT BE LESS THAN 44 INCHES IN WIDTH.

EVERY REQUIRED EXIT DOORWAY SHALL BE OF A SIZE AS TO PERMIT THE INSTALLATION OF A DOOR NOT LESS THAN 3 FEET IN WIDTH AND NOT LESS THAN 6 FEET 8-INCHES IN HEIGHT. WHEN INSTALLED IN EXIT DOORWAYS, EXIT DOORS SHALL BE CAPABLE OF OPENING AT LEAST 90 DEGREES AND SHALL BE SO MOUNTED THAT THE CLEAR WIDTH OF THE EXIT WAY IS NOT LESS THAN 32-INCHES.


FOR HINGED DOORS, THE OPENING WIDTH SHALL BE MEASURED WITH THE DOOR POSITIONED AT AN ANGLE OF 90 DEGREES FROM ITS CLOSED POSITION.

WHERE A PAIR OF DOORS IS UTILIZED, AT LEAST ONE OF THE DOORS SHALL PROVIDE A CLEAR UNOBSTRUCTED OPENING WIDTH OF 32-INCHES WITH THE LEAF POSITIONED AT AN ANGLE OF 90 DEGREES FROM ITS CLOSED POSITION.

MAXIMUM EFFORT TO OPERATE DOORS SHALL NOT EXCEED 8-1/2 LBS. FOR EXTERIOR DOORS AND 5 LBS. FOR INTERIOR DOORS, SUCH PULL OR PUSH EFFORT BEING APPLIED AT RIGHT ANGLES TO HINGED DOORS AND AT THE CENTER PLANE OF SHALL PROVIDE A MINIMUM 28-INCHES WIDE CLEAR SLIDING OR FOLDING DOORS. COMPENSATING DEVICES OR AUTOMATIC DOOR OPERATORS MAY BE UTILIZED TO MEET THE ABOVE STANDARDS. WHERE FIRE DOORS ARE REQUIRED, THE MAXIMUM EFFORT TO OPERATE THE DOOR MAY BE INCREASED NOT TO EXCEED 15 LBS.

5. THE BOTTOM 10-INCHES OF ALL DOORS EXCEPT AUTOMATIC AND SLIDING DOORS SHALL HAVE A SMOOTH UNINTERRUPTED SURFACE TO ALLOW THE DOOR TO BE OPENED BY A WHEELCHAIR FOOTREST WITHOUT CREATING A TRAP OR HAZARDOUS CONDITION. WHERE NARROW FRAME DOORS ARE USED, A 10-INCH HIGH SMOOTH PANEL SHALL BE INSTALLED ON THE PUSH SIDE OF THE DOOR, WHICH WILL ALLOW THE DOOR TO BE OPENED BY A WHEELCHAIR FOOTREST WITHOUT CREATING A TRAP OR HAZARDOUS CONDITION.


6. ALL ACCESSIBLE ENTRANCES SHALL BE IDENTIFIED WITH AT LEAST ONE STANDARD SIGN AND WITH ADDITIONAL DIRECTIONAL SIGNS, AS REQUIRED, VISIBLE FROM APPROACHING PEDESTRIAN WAYS.

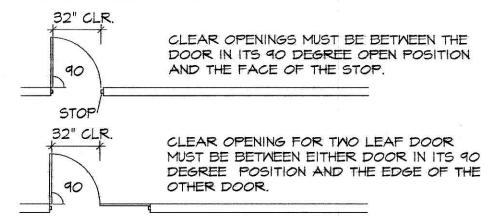


LEVEL FLOOR OR LANDING

THE FLOOR OR LANDING ON EACH SIDE OA AN EXIT DOOR SHALL BE LEVEL AND CLEAR. THE LEVEL AREA SHALL HAVE A LENGTH IN THE DIRECTION OF THE DOOR SWING OF AT LEAST 60 INCHES AND THE LENGTH OPPOSITE THE DIRECTION OF DOOR SWING 44 INCHES AS MEASURED AT RIGHT ANGLES TO THE PLANE OF THE DOOR IN ITS CLOSED POSITION.

2. THE WIDTH OF THE LEVEL AREA ON THE SIDE TO WHICH THE DOOR SWINGS SHALL EXTEND 24-INCHES PAST THE STRIKE EDGE OF THE DOOR FOR EXTERIOR DOORS AND 18-INCHES PAST THE STRIKE EDGE FOR INTERIOR DOORS

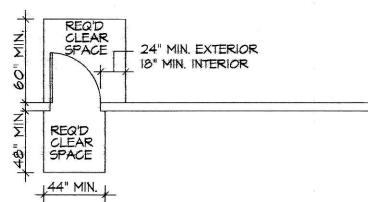

THE SPACE BETWEEN TWO CONSECUTIVE DOOR OPENINGS IN A VESTIBULE, SERVING OTHER THAN A REQUIRED EXIT STAIRWAY SHALL PROVIDE A MINIMUM OF 48-INCHES OF CLEAR SPACE FROM ANY DOOR OPENING INTO SUCH VESTIBULE WHEN THE DOOR IS POSITIONED AT AN ANGLE OF 90 DEGREES FROM ITS CLOSED POSITION. DOORS IN A SERIES SHALL SMING EITHER IN THE SAME DIRECTION OR AWAY FROM THE SPACE BETWEEN THE DOORS.

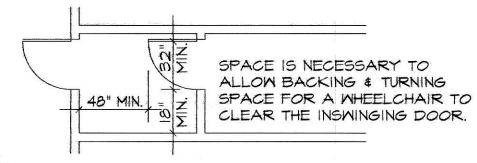

HAND ACTIVATED DOOR OPENING HARDMARE SHALL BE CENTERED BETMEEN 30-INCHES AND 44-INCHES ABOVE THE FLOOR. LATCHING AND LOCKING DOORS THAT ARE HAND ACTIVATED AND WHICH ARE IN A PATH OF TRAVEL, SHALL BE OPERABLE WITH A SINGLE EFFORT BY LEVER TYPE HARDWARE, BY PANIC BARS, PUSH-PULL ACTIVATING BARS, OR OTHER HARDWARE DESIGNED TO PROVIDE PASSAGE WITHOUT REQUIRING THE ABILITY TO GRASP THE OPENING HARDWARE.


IDENTIFICATION SYMBOLS

DOORWAYS LEADING TO MEN'S SANITARY FACILITIES SHALL BE IDENTIFIED BY AN EQUILATERAL TRIANGLE 1/4 INCH THICK WITH EDGES 12 INCHES LONG AND A VERTEX POINTING UPWARD. WOMEN'S SANITARY FACILITIES SHALL BE IDENTIFIED BY A CIRCLE, 1/4 INCH THICK AND 12 INCHES IN DIAMETER. UNISEX SANITARY FACILITIES SHALL BE IDENTIFIED BY A CIRCLE 1/4 INCH THICK, 12 INCHES IN DIAMETER WITH A 1/4 BE WALL HUNG WITH A RIM PROJECTING A MIN. OF INCH THICK TRIANGLE SUPERIMPOSED ON THE CIRCLE AND WITHIN THE 12 INCH DIAMETER. THESE GEOMETRIC SYMBOLS SHALL BE CENTERED N THE DOOR AT A HEIGHT OF 60 INCHES AND THEIR COLOR AND CONTRAST SHALL BE DISTINCTLY DIFFERENT FROM THE COLOR AND CONTRAST OF THE DOOR

MIRRORS SHALL BE MOUNTED WITH THE BOTTOM EDGE NO HIGHER THAN 40-INCHES | CONTROLS SHALL BE NO GREATER THAN 5 POUNDS FROM THE FLOOR.

THRESHOLDS

THE FLOOR OR LANDING SHALL BE NOT MORE THAN 1/2" LOWER THAN THE THRESHOLD OF A DOORWAY. CHANGE IN LEVEL BETWEEN 1/4 INCH AND 1/2 INCH SHALL BE BEVELED WITH A SLOPE NO GREATER THAN 1:2. CHANGE IN LEVEL GREATER THAN 1/2 INCH SHALL BE ACCOMPLISHED BY MEANS OF A RAMP

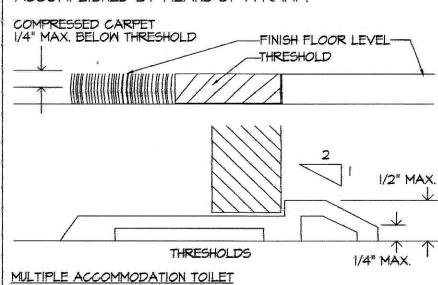

MULTIPLE ACCOMMODATION TOILET FACILITIES SHALL HAVE THE FOLLOWING:

WHEELCHAIR CLEARANCE: A CLEAR SPACE MEASURED FROM THE FLOOR TO A HEIGHT OF 27-INCHES ABOVE THE FACILITY ROOM, OF FLOOR, WITHIN THE SANITARY SUFFICIENT SIZE TO INSCRIBE A CIRCLE WITH A DIAMETER NOT LESS THAN 60-INCHES, OR A CLEAR SPACE 56-INCHES X 63-INCHES IN SIZE. DOORS OTHER THAN THE DOOR TO THE HANDICAPPED/PHYSICALLY DISABLED TOILET COMPARTMENT IN ANY POSITION MAY ENCROACH INTO THIS SPACE NOT MORE THAN 12-INCHES.

A WATER CLOSET FIXTURE LOCATED IN A COMPARTMENT SPACE FROM A FIXTURE OR A MINIMUM 32-INCHES WIDE CLEAR SPACE FROM A WALL AT ONE SIDE OF THE WATER CLOSET. A MINIMUM 48-INCHES LONG CLEAR SPACE SHALL BE PROVIDED IN FRONT OF THE WATER CLOSET IF THE COMPARTMENT HAS AN END OPENING DOOR (FACING THE WATER CLOSET). A 60-INCHES MINIMUM LENGTH CLEAR SPACE SHALL BE PROVIDED IN A COMPARTMENT WITH THE DOOR LOCATED AT THE SIDE. GRAB BARS SHALL NOT PROJECT MORE THAN 3-INCHES INTO THE CLEAR SPACES AS SPECIFIED ABOVE.

COMPARTMENT DOORS WATER CLOSET COMPARTMENT SHALL BE EQUIPPED WITH A DOOR THAT HAS AN AUTOMATIC CLOSING DEVICE, AND SHALL HAVE A CLEAR UNOBSTRUCTED OPENING WIDTH OF 32-INCHES WHEN LOCATED AT THE END AND 34-INCHES WHEN LOCATED AT THE SIDE WITH THE DOOR POSITIONED AT AN ANGLE OF 90 DEGREES FROM ITS CLOSED POSITION. WHEN STANDARD COMPARTMENT DOORS ARE USED, WITH MIN. 9-INCH CLEARANCE FOR FOOTRESTS UNDERNEATH AND A SELF-CLOSING DEVICE, CLEARANCE AT THE STRIKE EDGE AS SPECIFIED IS NOT REQUIRED.

EXCEPT FOR DOOR OPENING WIDTHS AND DOOR SWINGS, A CLEAR UNOBSTRUCTED ACCESS NOT LESS THAN 44-INCHES SHALL BE PROVIDED TO WATER CLOSET COMPARTMENTS DESIGNED FOR ACCESSIBILITY, AND THE SPACE IMMEDIATELY AND THE SPACE IMMEDIATELY IN FRONT OF A WATER CLOSET COMPARTMENT SHALL BE NOT LESS THAN 48-INCHES AS MEASURE AT RIGHT ANGLES TO THE COMPARTMENT DOOR IN ITS CLOSED

TOILET ROOM FIXTURES AND ACCESSORIES

TOILET ROOM FIXTURES AND ACCESSORIES

LAVATORY FIXTURES. THE REQUIREMENTS SHALL APPLY TO LAVATORY FIXTURES, VANITIES AND BUILT-IN LAVATORIES.

A CLEAR FLOOR SPACE 30-INCHES X 48-INCHES SHALL BE PROVIDED IN FRONT OF A LAVATORY TO ALLOW A FORWARD APPROACH. SUCH CLEAR FLOOR SPACE SHALL ADJOIN OR OVERLAP AN ACCESSIBLE ROUTE AND SHALL EXTEND INTO KNEE AND TOE SPACE UNDERNEATH THE LAVATORY.

2. LAVATORIES ADJACENT TO A WALL SHALL BE MOUNTED WITH A MIN. DISTANCE OF 18 INCHES TO THE CENTER LINE OF THE FIXTURE. ALL ACCESSIBLE LAVATORIES SHALL BE MOUNTED WITH THE RIM OR COUNTER SURFACE 34 INCHES MAXIMUM FROM THE FINISHED FLOOR AND WITH A CLEARANCE OF AT LEAST 29 INCHES FROM THE FLOOR TO THE BOTTOM OF THE APRON WITH KNEE CLEARANCE UNDER THE FRONT LIP DEPTH AT THE TOP. TOE CLEARANCE SHALL BE THE SAME APPLICATION OF A 250-POUND POINT LOAD SHALL BE WIDTH AND SHALL BE A MIN. OF 9-INCHES HIGH FROM THE FLOOR AND A MIN. 17-INCHES DEEP FROM THE FRONT OF

3. HOT WATER AND DRAIN PIPES ACCESSIBLE UNDER SHALL BE INSULATED OR OTHERWISE LAVATORIES COVERED. THERE SHALL BE NO SHARP OR ABRASIVE SURFACES UNDER LAYATORIES.

4. FAUCET CONTROLS AND OPERATING MECHANISMS SHALL BE OPERABLE WITH ONE HAND AND SHALL NOT REQUIRE TIGHT GRASPING, PINCHING OR TWISTING OF THE WRIST. THE FORCE REQUIRED TO ACTIVATE CONTROLS SHALL BE NO GREATER THAN 5 LBF. LEVER-OPERATED, PUSH-TYPE AND ELECTRONICALLY CONTROLLED MECHANISM ARE EXAMPLES OF ACCEPTABLE DESIGNS. SELF-CLOSING VALVES ARE ALLOWED IF THE FAUCET REMAINS OPEN FOR AT LEAST 10 SECONDS.

5. PEDESTAL LAVATORY - 17"MIN -19" MAX FIXTURE (BONL) PROJECTION. MATER CLOSETS

THE HEIGHT OF ACCESSIBLE WATER CLOSETS SHALL BE A MIN. IT-INCHES AND A MAX. OF 19-INCHES MEASURED BETWEEN THEIR FITTINGS. TO THE TOP OF THE TOILET SEAT. CONTROLS SHALL BE AUTOMATIC OR OPERABLE WITH ONE HAND, AND SHALL NOT REQUIRE TIGHT GRASPING, PINCHING OR TWISTING OF THE WRIST. CONTROLS FOR THE FLUSH VALVES SHALL BE 30-INCHES X 48-INCHES THAT ALLOWS EITHER A MOUNTED ON THE WIDE SIDE OF TOILET AREAS, NO MORE THAN 44-INCHES ABOVE THE FLOOR. THE FORCE REQUIRED TO ACTIVATE THE CONTROLS SHALL BE NO GREATER THAN 5 POUNDS FORCE.


WHERE URINALS ARE PROVIDED, AT LEAST ONE SHALL

ABOVE THE FLOOR SHALL BE PROVIDED

2. FLUSH CONTROLS SHALL BE AUTOMATIC OR OPERABLE WITH ONE HAND AND SHALL NOT REQUIRE TIGHT GRASPING, PINCHING OR TWISTING OF THE WRIST AND SHALL BE MOUNTED NO MORE THAN 44-INCHES ABOVE THE FLOOR. THE FORCE REQUIRED. TO ACTIVATE FORCE. FLUSH CONTROLS SHALL BE MOUNTED ON THE WIDE SIDE OF THE TOILET AREAS.

TOWELS, SANITARY NAPKINS, WASTE RECEPTACLES WHERE TOWEL, SANITARY NAPKINS, WASTE RECEPTACLES, AND OTHER SIMILAR DISPENSING AND DISPOSAL FIXTURES ARE PROVIDED, AT LEAST ONE OF


EACH TYPE SHALL BE LOCATED WITH ALL OPERABLE PARTS, INCLUDING COIN SLOTS, WITHIN 40-INCHES FROM THE FINISHED FLOOR.

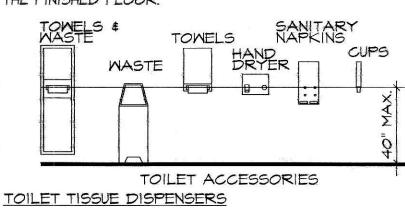


TOILET TISSUE DISPENSERS SHALL BE LOCATED ON THE SIDEMALL ADJACENT TO THE WATERCLOSET. THE OUTLET OF THE DISPENSER SHALL BE 14" MIN. AND 19" MAX. ABOVE THE FINISH FLOOR AND 24" MIN 42" MAX FROM THE FINISHED WALL OR PARTITION BEHIND THE

NATERCLOSET.

LOCATION GRAB BARS LOCATED ON EACH SIDE, OR ONE SIDE AND THE BACK OF THE PHYSICALLY HANDICAPPED/ACCESSIBLE TOILET STALL OR COMPARTMENT, SHALL BE SECURELY ATTACHED 33-INCHES THE OVERHANG SHALL BE NO GREATER THAN 19-INCHES. ABOVE AND PARALLEL TO THE FLOOR, EXCEPT THAT WHERE A TANK-TYPE TOILET IS USED WHICH OBSTRUCTS PLACEMENT AT 33-INCHES, THE GRAB BAR MAY BE AS HIGH AS 36-INCHES. GRAB BARS AT THE SIDE SHALL BE LOCATED 15 TO 16-1/2 (PLUS OR MINUS 1-INCH) INCHES FROM THE CENTER LINE OF THE WATER CLOSET STOOL, AND SHALL BE AT LEAST 42-INCHES LONG WITH THE FRONT END POSITIONED 24-INCHES IN FRONT OF THE WATER CLOSET STOOL. GRAB BARS AT THE BACK SHALL

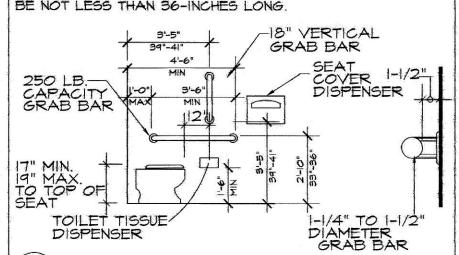

ACCESSIBLE SANITARY FACILITIES

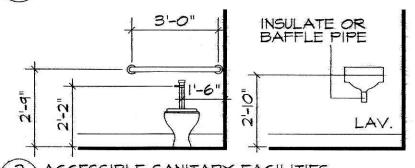

2 ACCESSIBLE SANITARY FACILITIES G-2/NOT TO SCALE

DIAMETER OR WIDTH: THE DIAMETER OR WIDTH OF THE GRIPPING SURFACES OF A GRAB BAR SHALL BE 1-1/4 INCHES TO 1-1/2 INCHES OR THE SHAPE SHALL PROVIDE AN EQUIVALENT GRIPPING SURFACE. IF GRAB BARS ARE MOUNTED ADJACENT TO A WALL, THE SPACE BETWEEN THE WALL AND THE GRAB BARS SHALL BE I 1/2 INCHES.

3. STRUCTURAL STRENGTH THE STRUCTURAL STRENGTH OF GRAB BARS, TUB AND SHOWER SEATS, FASTENERS, AND MOUNTING DEVICES SHALL MEET THE FOLLOWING SPECIFICATIONS:

BENDING STRESS IN A GRAB BAR OR SEAT INDUCED BY THE MAXIMUM BENDING MOMENT FROM THE APPLICATION OF A 250-POUND POINT LOAD SHALL BE LESS THAN THE ALLOWED STRESS FOR THE MATERIAL OF THE GRAB BAR

EXTENDING A MIN. 30 INCHES IN MIDTH WITH 8-INCHES MIN. SHEAR STRESS INDUCED IN A GRAB BAR OR SEAT BY THE LESS THAN THE ALLOWABLE SHEAR STRESS FOR THE MATERIAL OF THE GRAB BAR OR SEAT, AND ITS MOUNTING BRACKET OR OTHER SUPPORT IS CONSIDERED TO BE FULLY RESTRAINED, THEN DIRECT AND TORSIONAL SHEAR STRESSES SHALL NOT EXCEED THE ALLOWABLE SHEAR

> SHEAR FORCE INDUCED IN A FASTENER OR MOUNTING DEVICE FROM THE APPLICATION OF A 250-POUND POINT LOAD SHALL BE LESS THAN THE ALLOWABLE LATERAL LOAD OF EITHER THE FASTENER OR MOUNTING DEVICE OR THE SUPPORTING STRUCTURE, WHICHEVER IS THE SMALLER ALLOWABLE LOAD.

TENSILE FORCE INDUCED IN A FASTENER BY A DIRECT TENSION FORCE OF A 250-POUND POINT LOAD, PLUS THE MAXIMUM MOMENT FROM THE APPLICATION OF A 250-POUND POINT LOAD, SHALL BE LESS THAN THE ALLOWABLE WITHDRAWAL LOAD BETWEEN THE FASTENER AND SUPPORTING STRUCTURE.

SURFACE A GRAB BAR AND ANY WALL OR OTHER SURFACE ADJACENT TO IT SHALL BE FREE OF ANY SHARP OR ABRASIVE ELEMENTS. EDGES SHALL HAVE A MIN. RADIUS OF 1/8-INCH. GRAB BARS SHALL NOT ROTATE

CLEAR FLOOR GROUND SPACE: A CLEAR FLOOR OR GROUND SPACE AT LEAST FORWARD OR PARALLEL APPROACH BY A PERSON USING A WHEELCHAIR SHALL BE PROVIDED AT TELEPHONES.

2. SIZE AND APPROACH: THE MIN. CLEAR FLOOR GROUND SPACE REQUIRED TO ACCOMMODATE A SINGLE, STATIONARY WHEELCHAIR AND OCCUPANT IS 30-INCHES BY 48-INCHES. THE MIN. CLEAR 14-INCHES FROM THE WALL AND A MAXIMUM OF 17-INCHES | FLOOR OR GROUND SPACE FOR WHEELCHAIRS MAY BE POSITIONED FOR FORWARD OR PARALLEL APPROACH TO AN OBJECT. CLEAR FLOOR OR GROUND SPACE FOR WHEELCHAIRS MAY BE PART OF THE KNEE SPACE

> FLOOR SURFACES OF WHEELCHAIRS SPACES: BASES, ENCLOSURES AND FIXED SEATS SHALL NOT IMPEDE APPROACHES TO TELEPHONES BY PEOPLE WHO USE WHEELCHAIRS.

REQUIRED UNDER SOME OBJECTS.

4. RELATIONSHIP OF MANEUVERING CLEARANCES TO

WHEELCHAIR SPACES: ONE FULL UNOBSTRUCTED SIDE OF THE CLEAR FLOOR OR GROUND SPACE FOR A WHEELCHAIR SHALL ADJOIN ANOTHER WHEELCHAIR CLEAR FLOOR SPACE. IF A CLEAR FLOOR SPACE IS LOCATED IN AN ALCOVE OR OTHERWISE

THE HIGHEST OPERABLE PART OF THE TELEPHONE SHALL BE WITHIN THE REACH RANGES SPECIFIED. TELEPHONES USERS TO REACH DIAGONALLY SHALL HAVE THE HIGHEST OPERABLE PART NO HIGHER THAN 54-INCHES ABOVE THE

MANEUVERING CLEARANCES SHALL BE PROVIDED.

. HIGH FORWARD REACH: IF THE CLEAR FLOOR SPACE ONLY ALLOWS FORWARD APPROACH TO AN OBJECT, THE MAXIMUM HIGH FORWARD REACH ALLOWED SHALL BE 48-INCHES.

SIDE REACH: IF THE CLEAR FLOOR SPACE ONLY ALLOWS PARALLEL APPROACH BY A PERSON IN A WHEELCHAIR, THE MAXIMUM HIGH SIDE REACH ALLOWED NO LESS THAN 9-INCHES ABOVE THE FLOOR.

8. ENCLOSURES: IF TELEPHONE ENCLOSURES ARE PROVIDED, THEY MAY OVERHANG THE CLEAR FLOOR SPACE REQUIRED WITHIN THE FOLLOWING LIMITS:

THE HEIGHT OF THE LOWEST OVERHANGING PART SHALL BE EQUAL TO OR GREATER THAN 27-INCHES.

FULL-HEIGHT ENCLOSURES. ENTRANCES TO FULL-HEIGHT ENCLOSURES SHALL BE 30-INCHES MINIMUM.

FORWARD REACH REQUIRED: IF THE OVERHANG IS GREATER THAN 12-INCHES, THEN THE CLEAR WIDTH OF THE ENCLOSURES SHALL BE 30-INCHES MIN.; IF THE CLEAR WIDTH OF THE ENCLOSURE IS LESS THAN 30-INCHES, THEN THE HEIGHT OF THE LOWEST OVERHANGING PART SHALL BE EQUAL TO OR GREATER THAN 27-INCHES.

. PROTRUDING TELEPHONE ENCLOSURES:


OBJECTS PROJECTING FROM WALLS (FOR EXAMPLE, PHONES) WITH THEIR LEADING EDGES BETWEEN 27-INCHES RAMP SHALL NOT EXCEED I VERTICAL TO 12 HORIZONTAL AND 80-INCHES ABOVE THE FINISHED FLOOR SHALL PROTRUDE NO MORE THAN 4-INCHES INTO WALKS, HALLS, 5. CORRIDORS, PASSAGEWAYS OR AISLES. OBJECTS MOUNTED WITH THEIR LEADING EDGES AT OR BELOW 27-INCHES ABOVE THE FINISHED FLOOR MAY PROTRUDE ANY AMOUNT. FREE- STANDING OBJECTS MOUNTED ON 27-INCHES TO 80-INCHES ABOVE THE GROUND OR FINISHED FLOOR, PROTRUDING OBJECTS SHALL NOT REDUCE THE CLEAR WIDTH OF AN ACCESSIBLE ROUTE OR MANEUVERING SPACE.

WALKS, HALLS, CORRIDORS, PASSAGEWAYS, AISLES OR OTHER CIRCULATION SPACES SHALL HAVE 80-INCHES MINIMUM CLEAR HEAD ROOM. EQUIPMENT FOR HEARING IMPAIRED PEOPLE:

10. TELEPHONES SHALL BE EQUIPPED WITH A RECEIVER THAT GENERATES A MAGNETIC FIELD IN THE AREA OF THE RECEIVER CAP. IF BANKS OF PUBLIC TELEPHONES ARE PROVIDED. THEN A REASONABLE NUMBER, BUT ALWAYS AT LEAST ONE IN EACH BANK, IN A BUILDING OR FACILITY, SHALL BE EQUIPPED WITH A VOLUME CONTROL. AND A TOTAL OF AT LEAST 25% OF THE TOTAL NUMBER OF PUBLIC TELEPHONES.

CONTROLS: TELEPHONES SHALL HAVE PUSH-BUTTON CONTROLS WHERE SERVICE FOR SUCH EQUIPMENT IS AVAILABLE.

12. CORD LENGTH: THE CORD FROM THE TELEPHONE TO THE HANDSET SHALL BE AT LEAST 29-INCHES LONG.

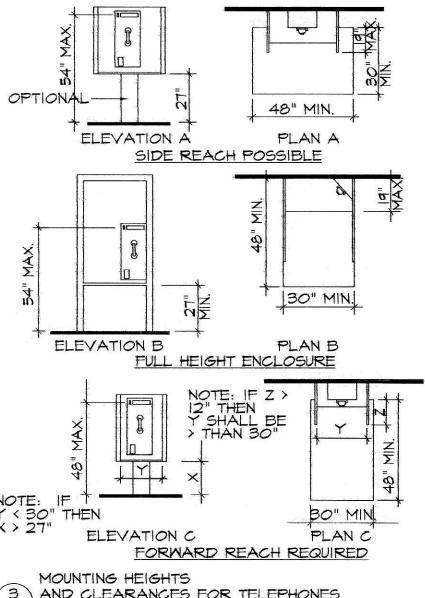

3 AND CLEARANCES FOR TELEPHONES G-2 NOT TO SCALE SIGNS SHALL COMPLY WITH 2009 ICC/ANSI 703.1

CONTRACTED

BRAILLE SHALL'

COMPLY WITH_

2009 ICC/ANSI

6 ACCESSIBILITY SIGN

5-2 NOT TO SCALE

(GRADE 2)

703.4

WALKS AND SIDEWALKS

WALKS AND SIDEWALKS SUBJECT TO THESE REGULATIONS SHALL HAVE A CONTINUOUS COMMON SURFACE, UNINTERRUPTED BY STEPS OR BY ABRUPT CHANGES IN LEVEL EXCEEDING 1/2 INCH AND SHALL BE A MIN. OF 48-INCHES IN

CONFINED ON ALL OR PART OF THREE SIDES, ADDITIONAL 2. SURFACES WITH A SLOPE OF LESS THAN 6% GRADIENT SHALL BE AT LEAST AS SLIP-RESISTANT AS THAT DESCRIBED AS A MEDIUM SALTED FINISH. SURFACES WITH A SLOPE OF 6% GRADIENT OR GREATER SHALL BE

SLIP-RESISTANT. MOUNTED DIAGONALLY IN A CORNER REQUIRE WHEELCHAIR 4. WHEN THE SLOPE IN THE DIRECTION OF TRAVEL OF ANY WALK EXCEEDS I VERTICAL IN 20 HORIZONTAL (5% GRADIENT) IT SHALL COMPLY WITH THE

PROVISIONS FOR PEDESTRIAN RAMPS. SURFACE CROSS SLOPES SHALL NOT EXCEED 1/4 INCH/FOOT.

WALKS, SIDEWALKS AND PEDESTRIAN WAYS SHALL BE FREE OF GRATINGS WHENEVER POSSIBLE. FOR GRATINGS LOCATED IN THE SURFACE OF ANY OF THESE AREAS, GRID OPENINGS IN GRATINGS SHALL BE LIMITED TO 1/2-INCH IN THE DIRECTION OF TRAFFIC FLOW.

ABRUPT CHANGES IN LEVEL ALONG ANY ACCESSIBLE ROUTE SHALL NOT EXCEED 1/2-INCH. WHEN CHANGES IN LEVEL DO OCCUR, THEY SHALL BE BEVELED SIDEWALK. SHALL BE 54-INCHES AND THE LOW SIDE REACH SHALL BE WITH A SLOPE NO GREATER THAN 1:2 EXCEPT THAT LEVEL CHANGES NOT EXCEEDING 1/4-INCH MAY BE VERTICAL.

> WHEN CHANGE IN LEVELS GREATER THAN 1/2-INCH ARE NECESSARY, THEY SHALL COMPLY WITH THE REQUIREMENTS FOR CURB RAMPS

WALKS SHALL BE PROVIDED WITH A LEVEL AREA NOT LESS THAN 60-INCHES X 60-INCHES AT A DOOR OR GATE THAT SWINGS TOWARD THE WALK, AND NOT LESS PICTOGRAMS SHALL COMPLY WITH 2012 NSCBC SEC. IIIO, THAN 48-INCHES WIDE BY 44-INCHES DEEP AT A DOOR OR GATE THAT SMINGS AWAY FROM THE WALK. SUCH WALKS SHALL EXTEND 24-INCHES TO THE SIDE OF THE STRIKE EDGE OF A DOOR OR GATE THAT SWINGS TOWARD THE WALK.

IO. ALL WALKS WITH CONTINUOUS GRADIENTS SHALL HAVE LEVEL AREAS OF AT LEAST 5 FEET IN LENGTH AT INTERVALS OF AT LEAST EVERY 400 FEET.

CURB RAMPS SHALL BE CONSTRUCTED AT EACH CORNER OF STREET ITERSECTIONS AND WHERE A PEDESTRIAN WAY CROSSES A CURB.

CURB RAMPS SHALL BE A MINIMUM OF 4 FEET IN WIDTH AND SHALL LIE GENERALLY, IN A SINGLE SLOPED PLANE, WITH A MIN. SURFACE WARPING AND CROSS SLOPE.

THE SLOPE OF CURB RAMPS SHALL NOT EXCEED I VERTICAL TO 12 HORIZONTAL. THE SLOPE OF THE FANNED OR FLARED SIDES OF CURB RAMPS SHALL NOT EXCEED I VERTICAL TO 8 HORIZONTAL


A LEVEL LANDING OF 4 FEET DEEP SHALL BE PROVIDED AT THE UPPER END OF EACH CURB RAMP OVER ITS FULL WIDTH TO PERMIT SAFE EGRESS FROM THE RAMP SURFACE, OR THE SLOPE OF THE FANNED OR FLARED SIDES OF THE CURB


THE SURFACE OF EACH CURB RAMP AND ITS FLARED SIDES SHALL BE SLIP-RESISTANT AND SHALL BE OF CONTRASTING FINISH FROM THAT OF THE ADJACENT SIDEWALK.

THE SURFACE OF EACH CURB RAMP LOCATED IN THE CENTER OF THE CURB POSTS OR PYLONS MAY OVERHANG 12-INCHES MAX. FROM RETURN SHALL BE GROOVED PARALLEL TO THE CENTER LINE OF THE CROSSWALKS TYPICALLY IN TWO DIRECTIONS WITH 1/4-INCH X 1/4-INCH GROOVES APPROX. 1-1/2-INCHES ON CENTER.

> ALL CURB RAMPS SHALL HAVE A GROOVED BORDER 12-INCHES WIDE AT THE LEVEL SURFACE OF THE SIDEMALK ALONG THE TOP AND EACH SIDE APPROX. 3/4-INCH ON CENTER. ALL CURB RAMPS CONSTRUCTED BETWEEN THE FACE OF THE CURB AND THE STREET SHALL HAVE A GROOVED BORDER AT THE LEVEL SURFACE OF THE SIDEWALK.

NOTE: THE SURFACE OF EACH PARKING SPACE SHALL HAVE A SURFACE IDENTIFICATION DUPLICATING THE SYMBOL OF ACCESSIBILITY CONSISTING OF A WHITE FIGURE ON A BLUE BACKGROUND, AT LEAST 3'-O" SQUARE

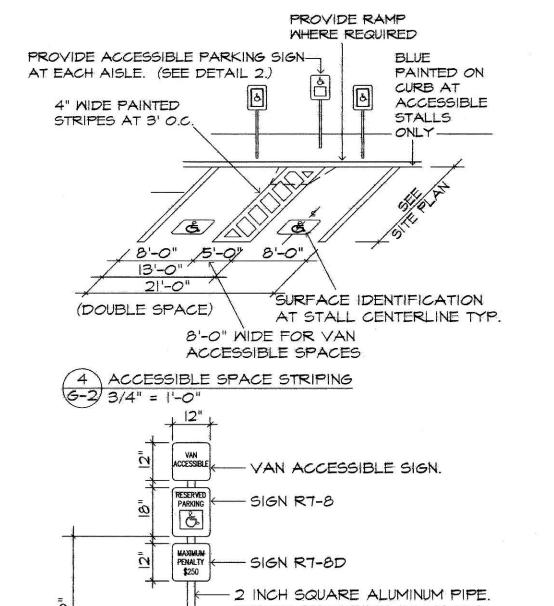

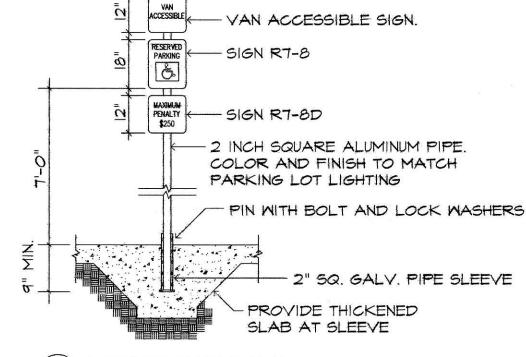

(5) ACCESSIBLE AISLE SIGN (G-2) NOT TO SCALE

PICTOGRAMS AND THEIR FIELDS SHALL HAVE A NON-GLARE FINISH. PICTOGRAMS SHALL CONTRAST WITH THEIR FIELDS, WITH EITHER A LIGHT PICTOGRAM ON A DARK FIELD OR A DARK PICTOGRAM ON A LIGHT FIELD. ICC/ ANSI 703.5.3 CHARACTER HEIGHT DETERMINED

BY 2009 ICC/ANSI TABLE 703.2.4

DIAMETER GRIPPABLE HANDRAIL HANDRAIL G-2 NOT TO SCALE

THE LOWER END OF EACH CURB RAMP SHALL HAVE A 1/2-INCH LIP BEVELED AT 45 DEGREES.

WHEN CHANGES IN LEVELS GREATER THAN 1/2-INCH ARE NECESSARY, THEY SHALL COMPLY WITH REQUIREMENTS FOR THESE DRAWINGS ARE DIAGRAMMATIC, NO.

CURB RAMPS. ADDITIONAL REQUIREMENTS

THE CENTER OF RECEPTACLE OUTLETS SHALL BE NOT LESS THAN 15-INCHES ABOVE THE FLOOR OR WORKING

2. THE CENTER OF THE GRIP OF THE OPERATING HANDLE OF SWITCHES INTENDED TO BE USED BY THE OCCUPANT OF THE ROOM OR AREA TO CONTROL LIGHTING AND RECEPTACLE OUTLETS, APPLIANCES, OR COOLING, HEATING AND VENTILATING EQUIPMENT, SHALL BE NOT LESS THAN 3-FEET NOR MORE THAN 4-FEET ABOVE THE FLOOR OR MORKING PLATFORM.

3. THE CENTER OF FIRE ALARM INITIATING DEVICES (BOXES) SHALL BE LOCATED 48-INCHES ABOVE THE LEVEL OF THE FLOOR, WORKING PLATFORM, GROUND SURFACE OR

4. THE INTERNATIONAL SYMBOL OF ACCESSIBILITY SHALL BE THE STANDARD USED TO IDENTIFY FACILITIES THAT ARE ACCESSIBLE TO AND USABLE BY PHYSICALLY DISABLED PERSONS AS SET FORTH IN THESE BUILDING STANDARDS. THE SYMBOL SPECIFIED ABOVE SHALL HAVE TACTILE TEXT DESCRIPTORS. TACTILE CHARACTERS AND APPX E107, \$ 2009 ICC/ANSI A117.1


5. IF EMERGENCY WARNING SYSTEMS ARE REQUIRED THEY SHALL ACTIVATE A MEANS OF WARNING FOR THE HEARING IMPAIRED. FLASHING VISUAL WARNING SHALL HAVE A FREQUENCY OF NOT MORE THAN 60 FLASHES PER MINUTE.

. PROVIDE 2-INCHES WIDE STRIP IN CONTRASTING COLOR AT UPPER APPROACH AND LOWER TREAD OF EACH FLIGH OF INTERIOR STAIRS AND EVERY TREAD OF EXTERIOR STAIRS AS SLIP RESISTANT AS OTHER TREADS OF THE

. HANDRAILS PROJECTING FROM A WALL SHALL HAVE A -1/2" CLEAR SPACE BETWEEN THE RAIL AND THE WALL THE HAND GRIP SHALL BE MINIMUM 1-1/4" AND MAXIMUM 2" IN CROSS SECTIONAL DIMENSION AND BE SMOOTH SURFACED WITH NO SHARP CORNERS.

. ALL ENTRANCES AND ALL EXTERIOR GROUND FLOOR EXIT DOORS TO BUILDINGS AND FACILITIES SHALL BE MADE ACCESSIBLE TO PERSONS WITH DISABILITIES.

10. IN BUILDINGS AND FACILITIES, FLOORS OF A GIVEN STORY SHALL BE A COMMON LEVEL THROUGHOUT OR SHALL BE CONNECTED BY PEDESTRIAN RAMPS, PASSENGER ELEVATORS, OR SPECIAL ACCESS LIFTS.

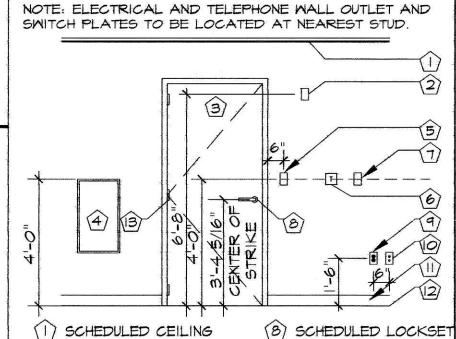

OR LATCHSET AS

REQUIRED (LEVER

MOUNTED VERTICAL

TELEPHONE OUTLET

SCHEDULED BASE

OPERATED).

(9) DUPLEX ELECTRICAL

WALL OUTLET


1) SCHEDULED CEILING (2) STROBE LIGHT

(3) SCHEDULED DOOR AND (4) FIRE EXTINGUISHER

CABINET (5) SWITCH PLATE -DOTTED LINE INDICATED LARGER PLATE AS REQUIRED.

(12) SCHEDULED FLOOR (6) THERMOSTAT FINISH (7) PULL STATION (13) ELECTRICAL HINGE LOCATION W/JUCTION

TYPICAL MOUNTING HEIGHTS (G-2) NOT TO SCALE

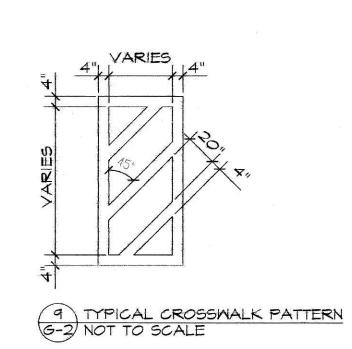

THIS SYMBOL TO BE WHITE D.O.T. (DEPARTMENT OF RANSPORTATION) PAINT ON BLUE D.O.T. BACKGROUND.

10 SIGNAGE DETAIL G-2 NOT TO SCALE

THESE DRAWINGS ARE DIAGRAMMATIC, NOT INCLIDING ALL CONDITIONS AND DETAILS, AND ARE INTENDED TO BE USED BY EXPERIENCED MECHANICS, EACH DRAWING IS COMPLIMENTARY TO THE OTHERS, ALL CONDITIONS AND DIMENSIONS MUST BE VERIFIED BY THE CONTRACTORS PRIOR TO INSTALLATION, MORK PERFORMED NOT IN COMPLIANCE WITH THE INTENT OF THESE DOCUMENTS ARE THE RESPONSIBILITY OF THE PERSONS PERFORMING THE WORK, LIMIT OF LIABILITY IS THE AMOUNT OF FEE CHARGED. THE PROPERTY OF CARLOS MOORE ARCHITECT PANY REPRODUCTION, ALTERATION, OR USE FOR OTHER THAN THE INTENDED PROJECT, WITHOUT WRITTEN CONSENT OF CARLOS MOORE ARCHITECT PA IS STRICTLY FORBIDDEN. OPYRIGHT 2021 CARLOS MOORE ARCHITECT PA

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AND REGULATIONS SHALL BE CONSIDERED AS A
PART OF PLANS AND SPECIFICATIONS FOR THIS
BUILDING AND SHALL TAKE REFERENCE OVER
ANYTHING SHOWN, DESCRIBED OR IMPLIED WHERE


ERED 46 OPTH CAROLIN ONCORD. ORE ARCH! CERT. NO. 51212 ORTH CAROLING , ONCORD.

TODAY'S DATE: 09.10.2021

SCHEMATIC DESIGN APPR: XXX ORIGINAL SEAL DATE: XXX REVISIONS

DRAWING #: 210805 G2 DRAWN BY: RGW PROJECT MGR: VLM CHECKED BY: V. MOORE

=

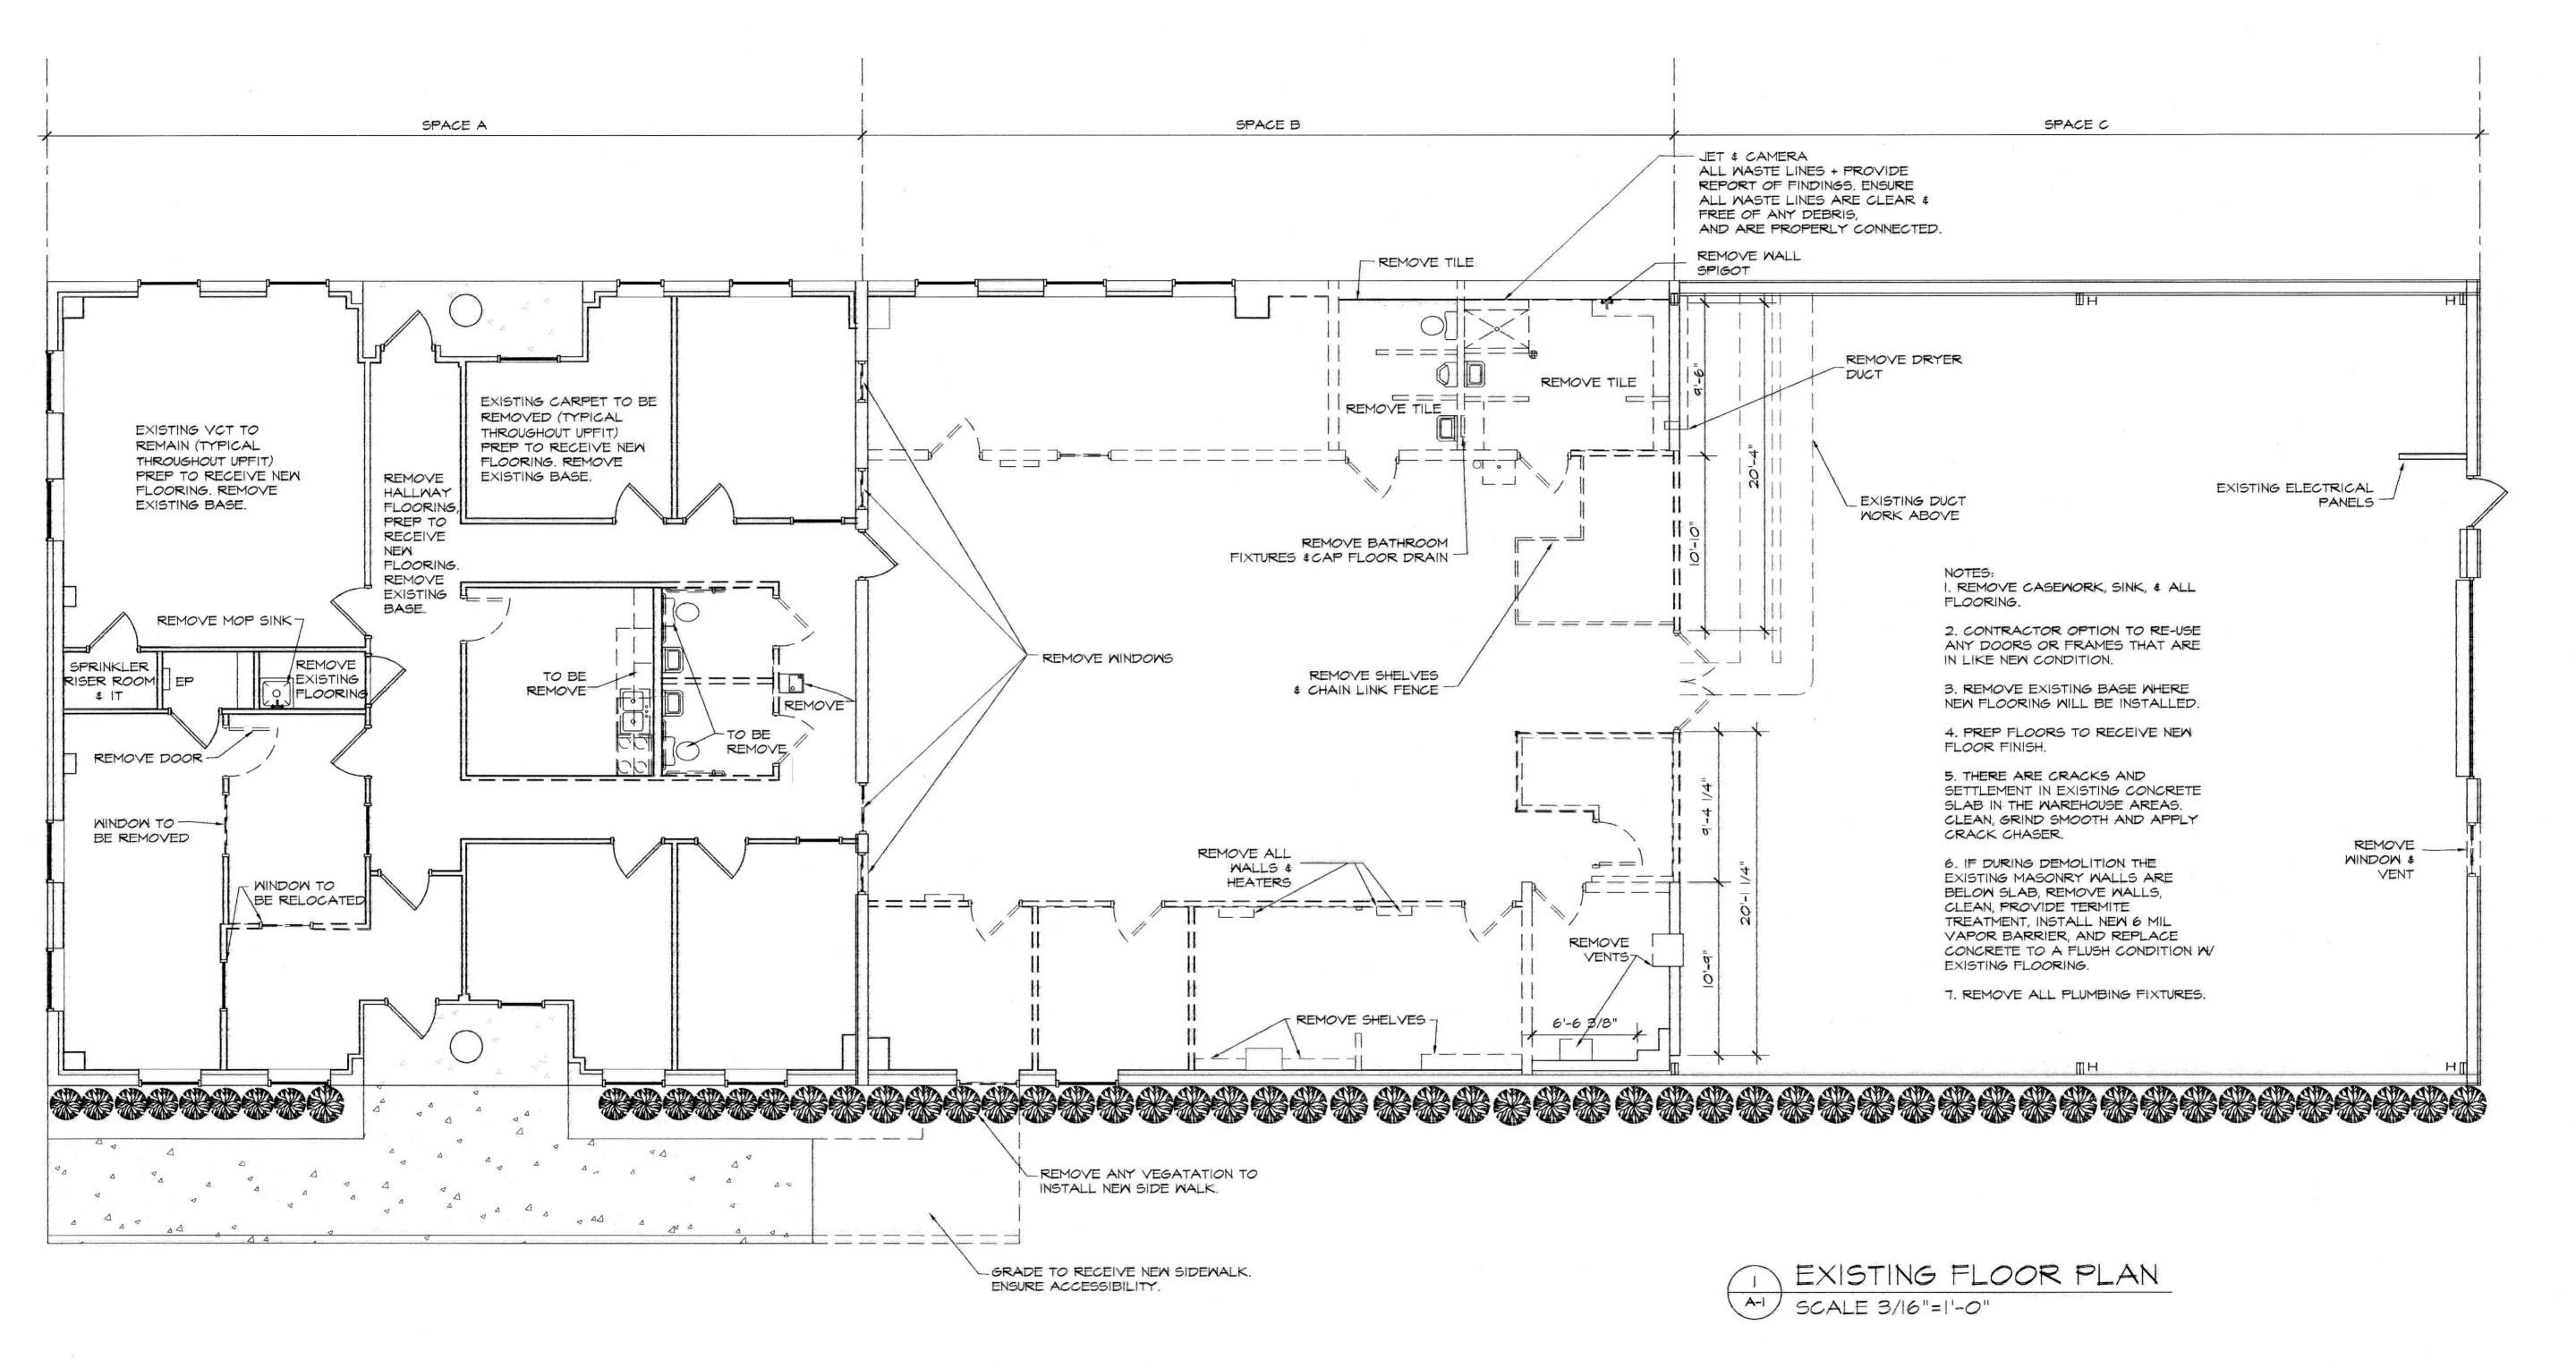

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TODAY'S DATE: 09.10.2021 SCHEMATIC DESIGN APPR. XXX ORIGINAL SEAL DATE: XXXXXXX

REVISIONS:

WALL LEGEND

ALL PLUMBING FIXTURES TO

TO REMAIN

__ _ EXISTING WALL TO BE

BE REMOVED UNLESS NOTED OTHERWISE.


MAINTAIN WATER LINES IN REMAINING WALLS FOR PROPOSED FIXTURES.

REMOVED

EXISTING EXTERIOR WALL

DRAWING NUMBER: 210805 EFP DRAWN BY: RGM PROJECT MGR: VLM CHECKED BY: V. MOORE

TOTAL # OF

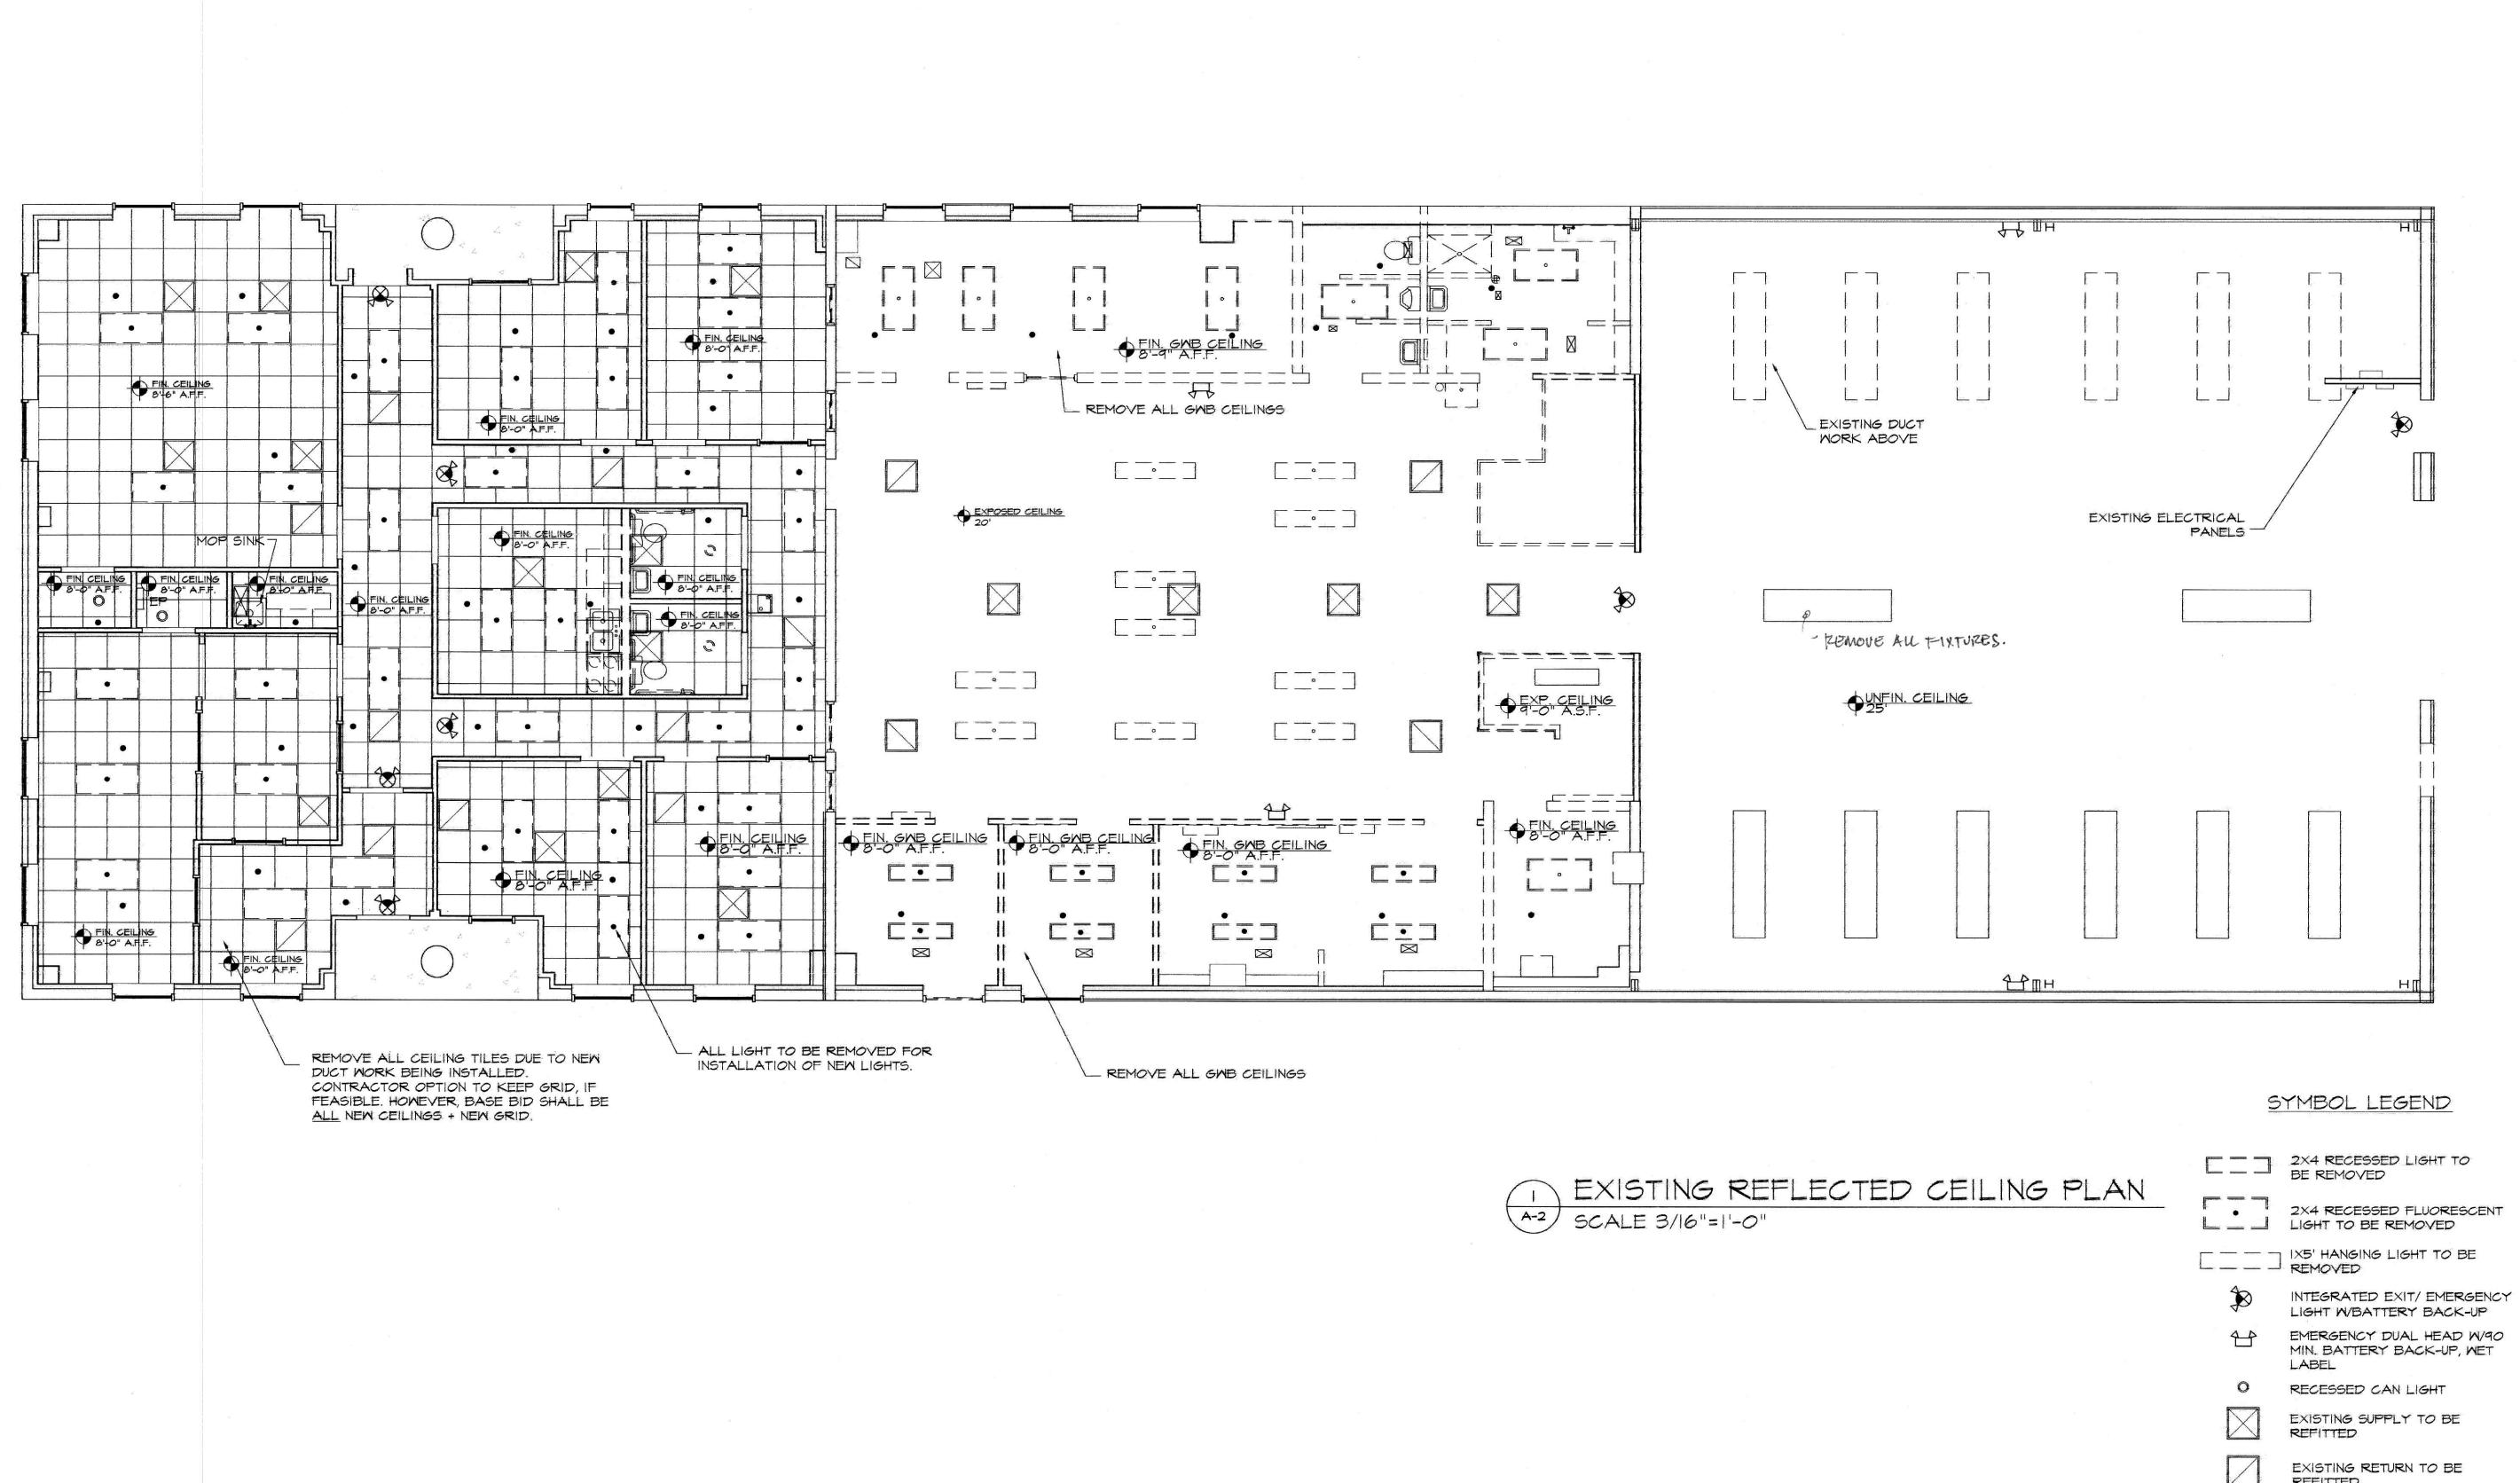

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AND RESULATIONS SHALL BE CONSIDERED AS A
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でを下口

TODAY'S DATE: 09.10.2021 SCHEMATIC DESIGN APPR: XXX ORIGINAL SEAL DATE: XXXXXXX

REVISIONS:

DRAWN BY: RGW

PROJECT MGR: VLM


EMERGENCY DUAL HEAD W/90 MIN. BATTERY BACK-UP, WET

REFITTED EXISTING SUPPLY TO BE

REMAIN SPRINKLER HEAD SHEET ___ TOTAL # OF SHEETS: 28

CHECKED BY: V. MOORE

DRAWING NUMBER: 210805 ERCF

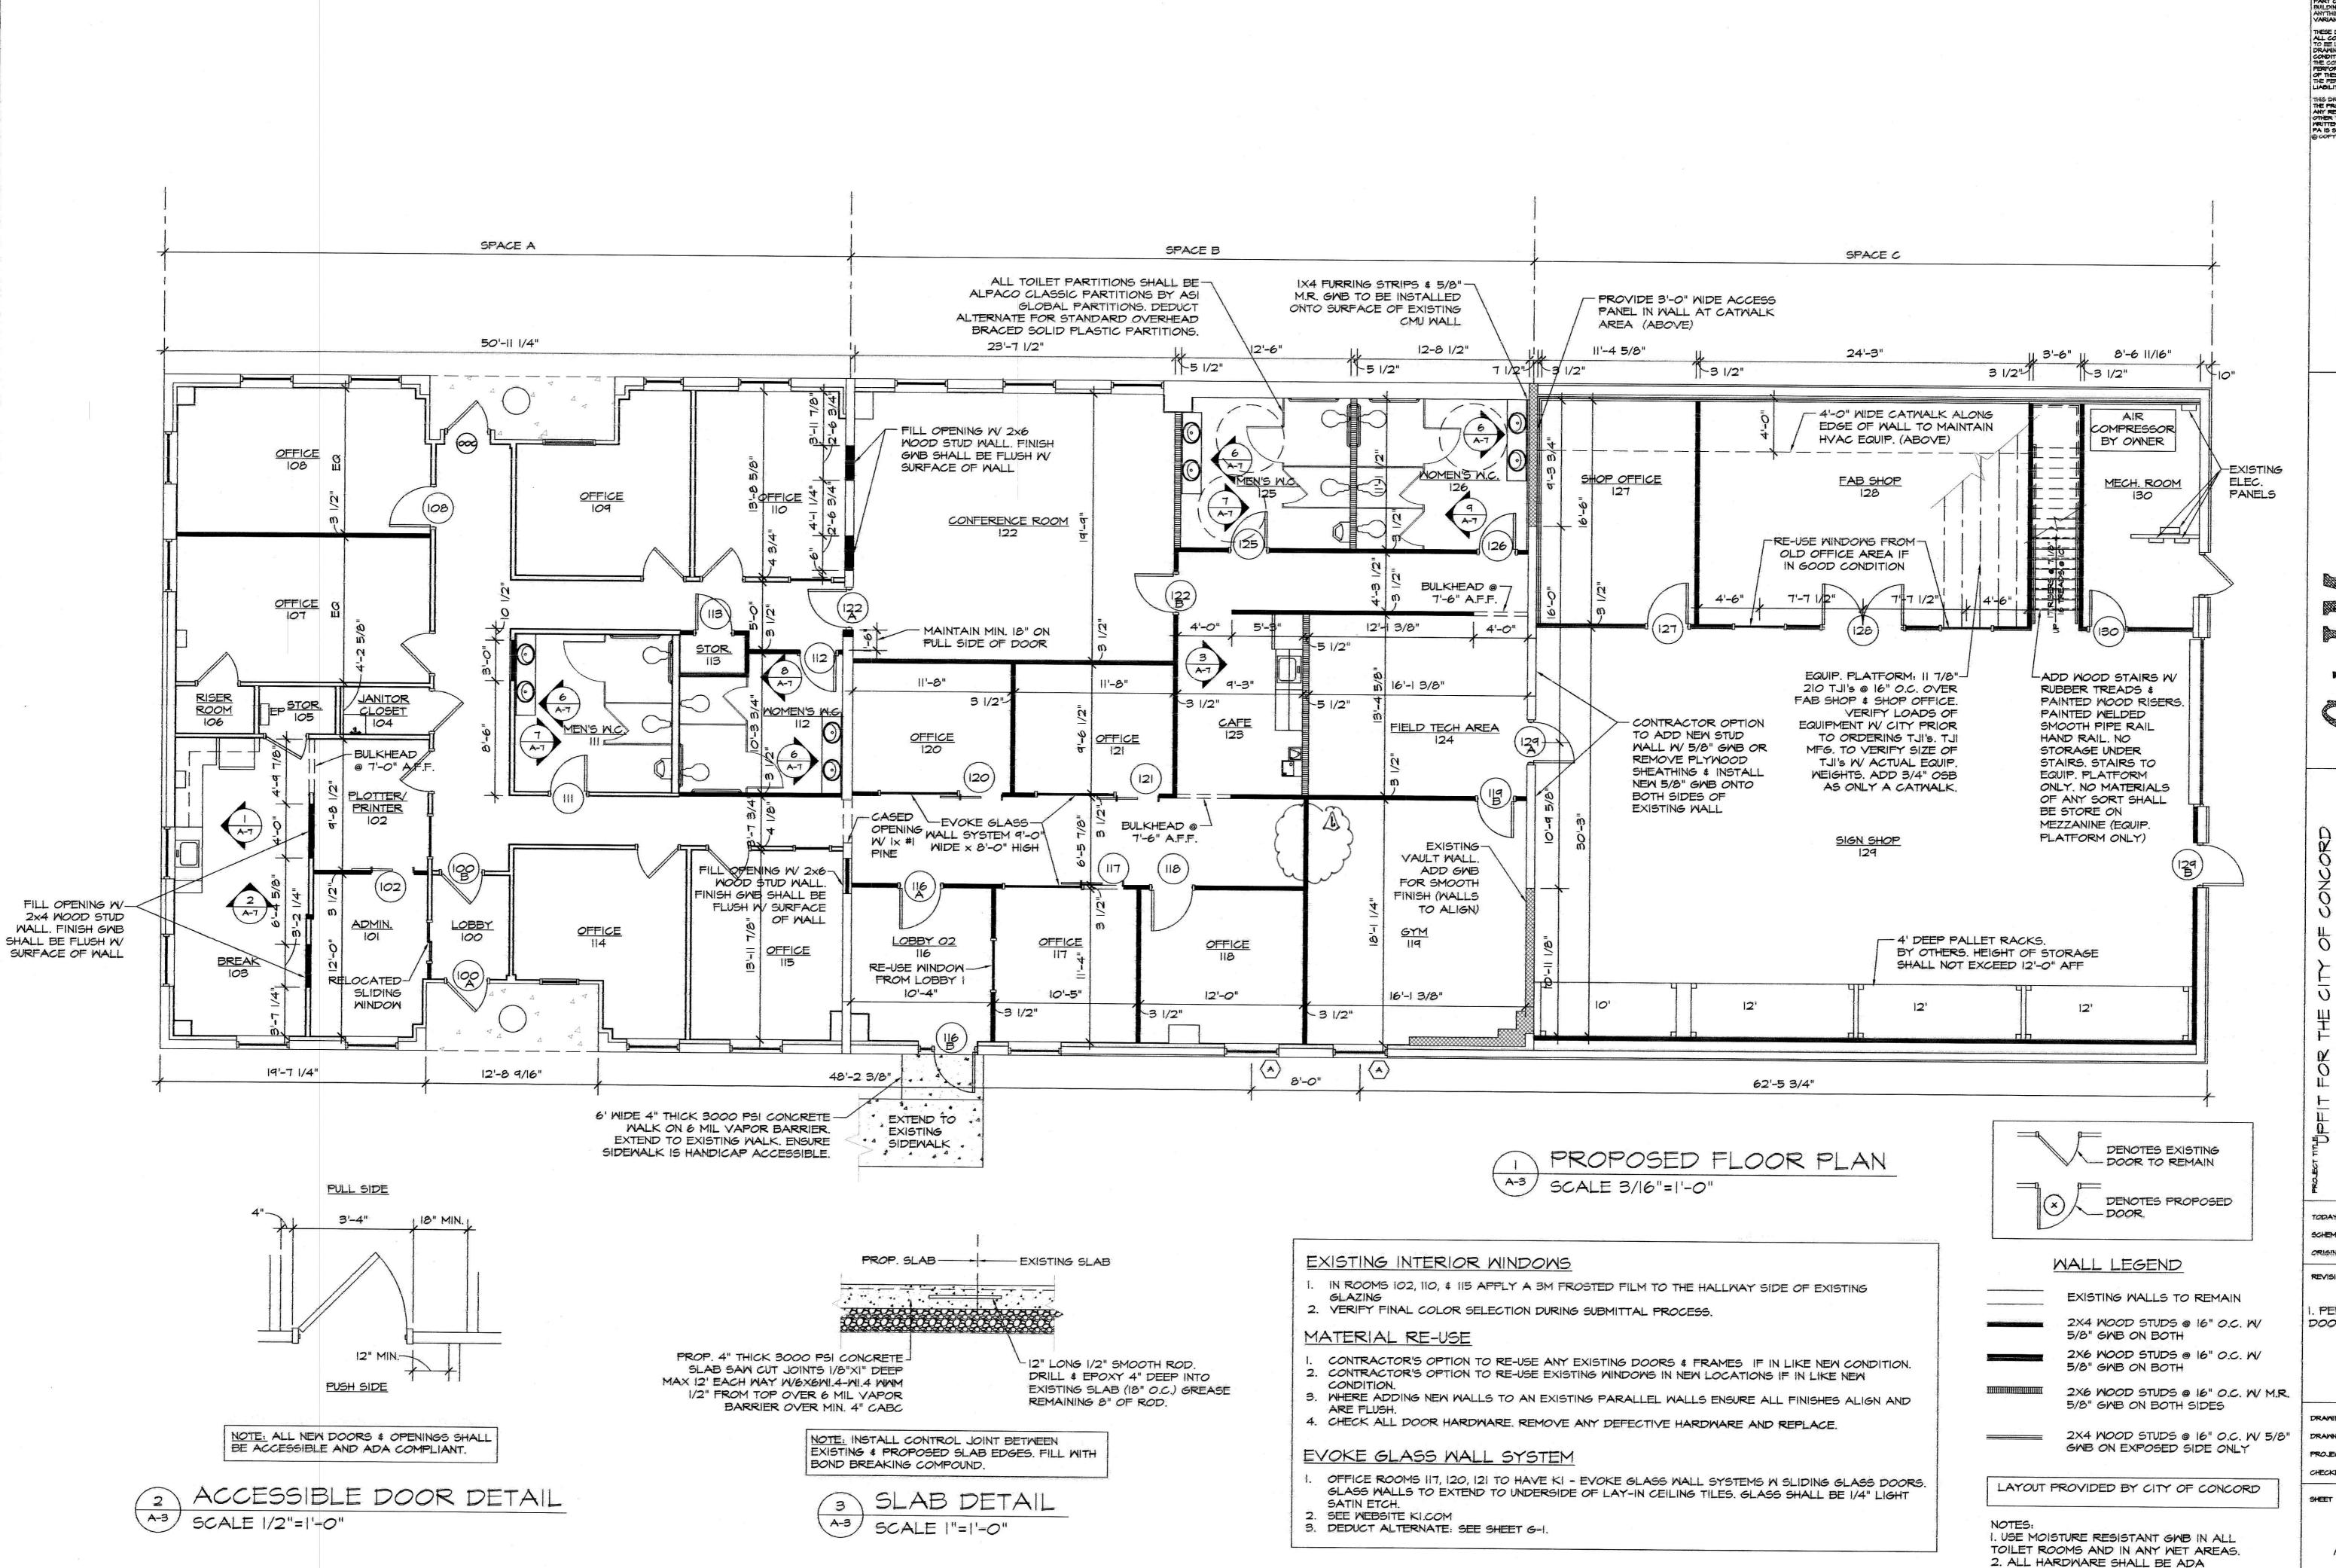

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OVCORD. NO.

ARCHITECT P.

ARCHITECT P.

N. CONCORD, NC 28025

33 F-104.182.0481

222 CHURCH ST. N. CONCOR T-104.188.8333 F-104

TRANSPORTATION DEPT.

2 GENERAL SERVICES DR, CONCORD, NOTES.

PROPOSED FILOOR PLAN

TODAY'S DATE: 09.14.2021
SCHEMATIC DESIGN APPR: XXX
ORIGINAL SEAL DATE: 09.10.2021

PER OWNER DELETED

DOOR 19A


DRAWING NUMBER: 210805 FP DRAWN BY: RGW REV 2 PROJECT MGR: VLM

CHECKED BY: V. MOORE

SHEET

TOTAL * OF SHEETS: 28

COMPLIANT & LEVER TYPE HANDLES.

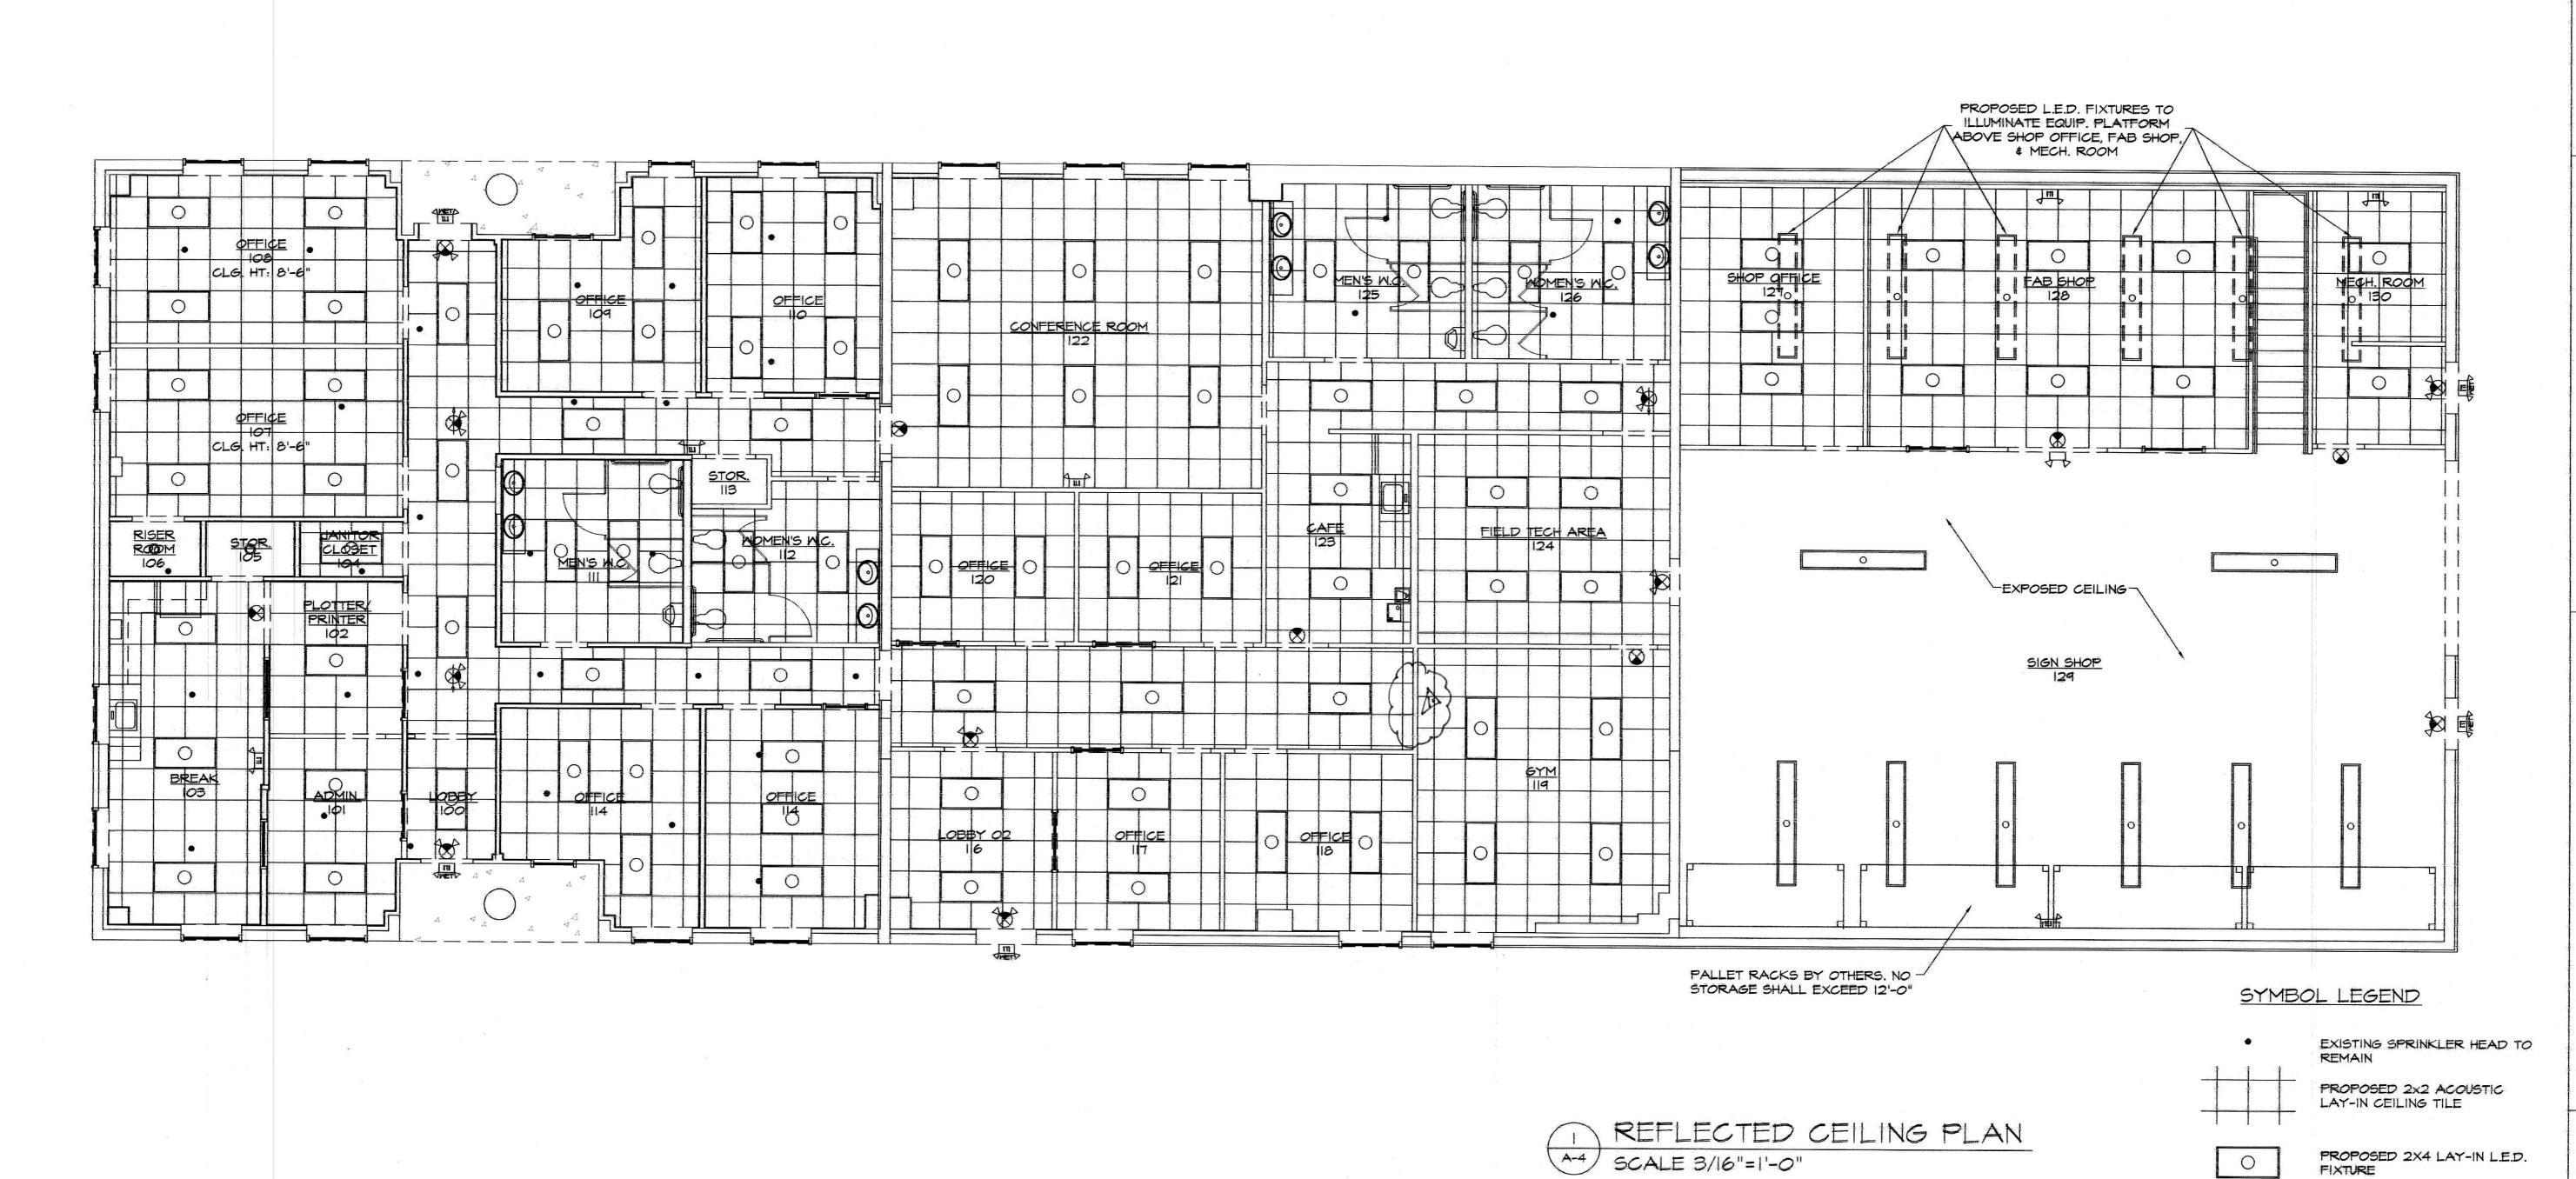

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187 PA

TODAY'S DATE: 09.14.2021 SCHEMATIC DESIGN APPR. XXX

ORIGINAL SEAL DATE: 09.10.2021

<u>/i.</u> 09.14.2021 . PER OWNER DELETED DOOR 19A

0

0

I. ALL LAY-IN CEILING GRIDS TO BE AT 8'-O" A.F.F.

PERFORMA BAROQUE MINERAL FIBER CEILINGS OR

2. LAY IN CEILINGS SHALL BE CERTAINTEED

EQUAL. 24X24 FLAT PANELS. (NO REVEALS)

UNLESS OTHERWISE NOTED.

PROPOSED RECESSED CAN

PROPOSED L.E.D. FIXTURE

INTEGRATED EXIT LIGHT W

DIRECTIONAL SIGNAGE AS

DIRECTIONAL SIGNAGE AS

INTEGRATED EXIT/EMERGENCY LIGHT W/ BATTERY BACK UP \$

EMERGENCY DUAL HEAD W/90 MIN. W BATTERY BACK-UP

EMERGENCY LIGHT W BATTERY

BACK UP, WET LABEL

BATTERY BACK UP \$

LIGHT

REQUIRED


REQUIRED

DRAWING NUMBER: 210805 RCP DRAWN BY, RGW/DCOK REV2

PROJECT MGR: VLM CHECKED BY: V. MOORE

= 4

TOTAL * OF SHEETS: 28

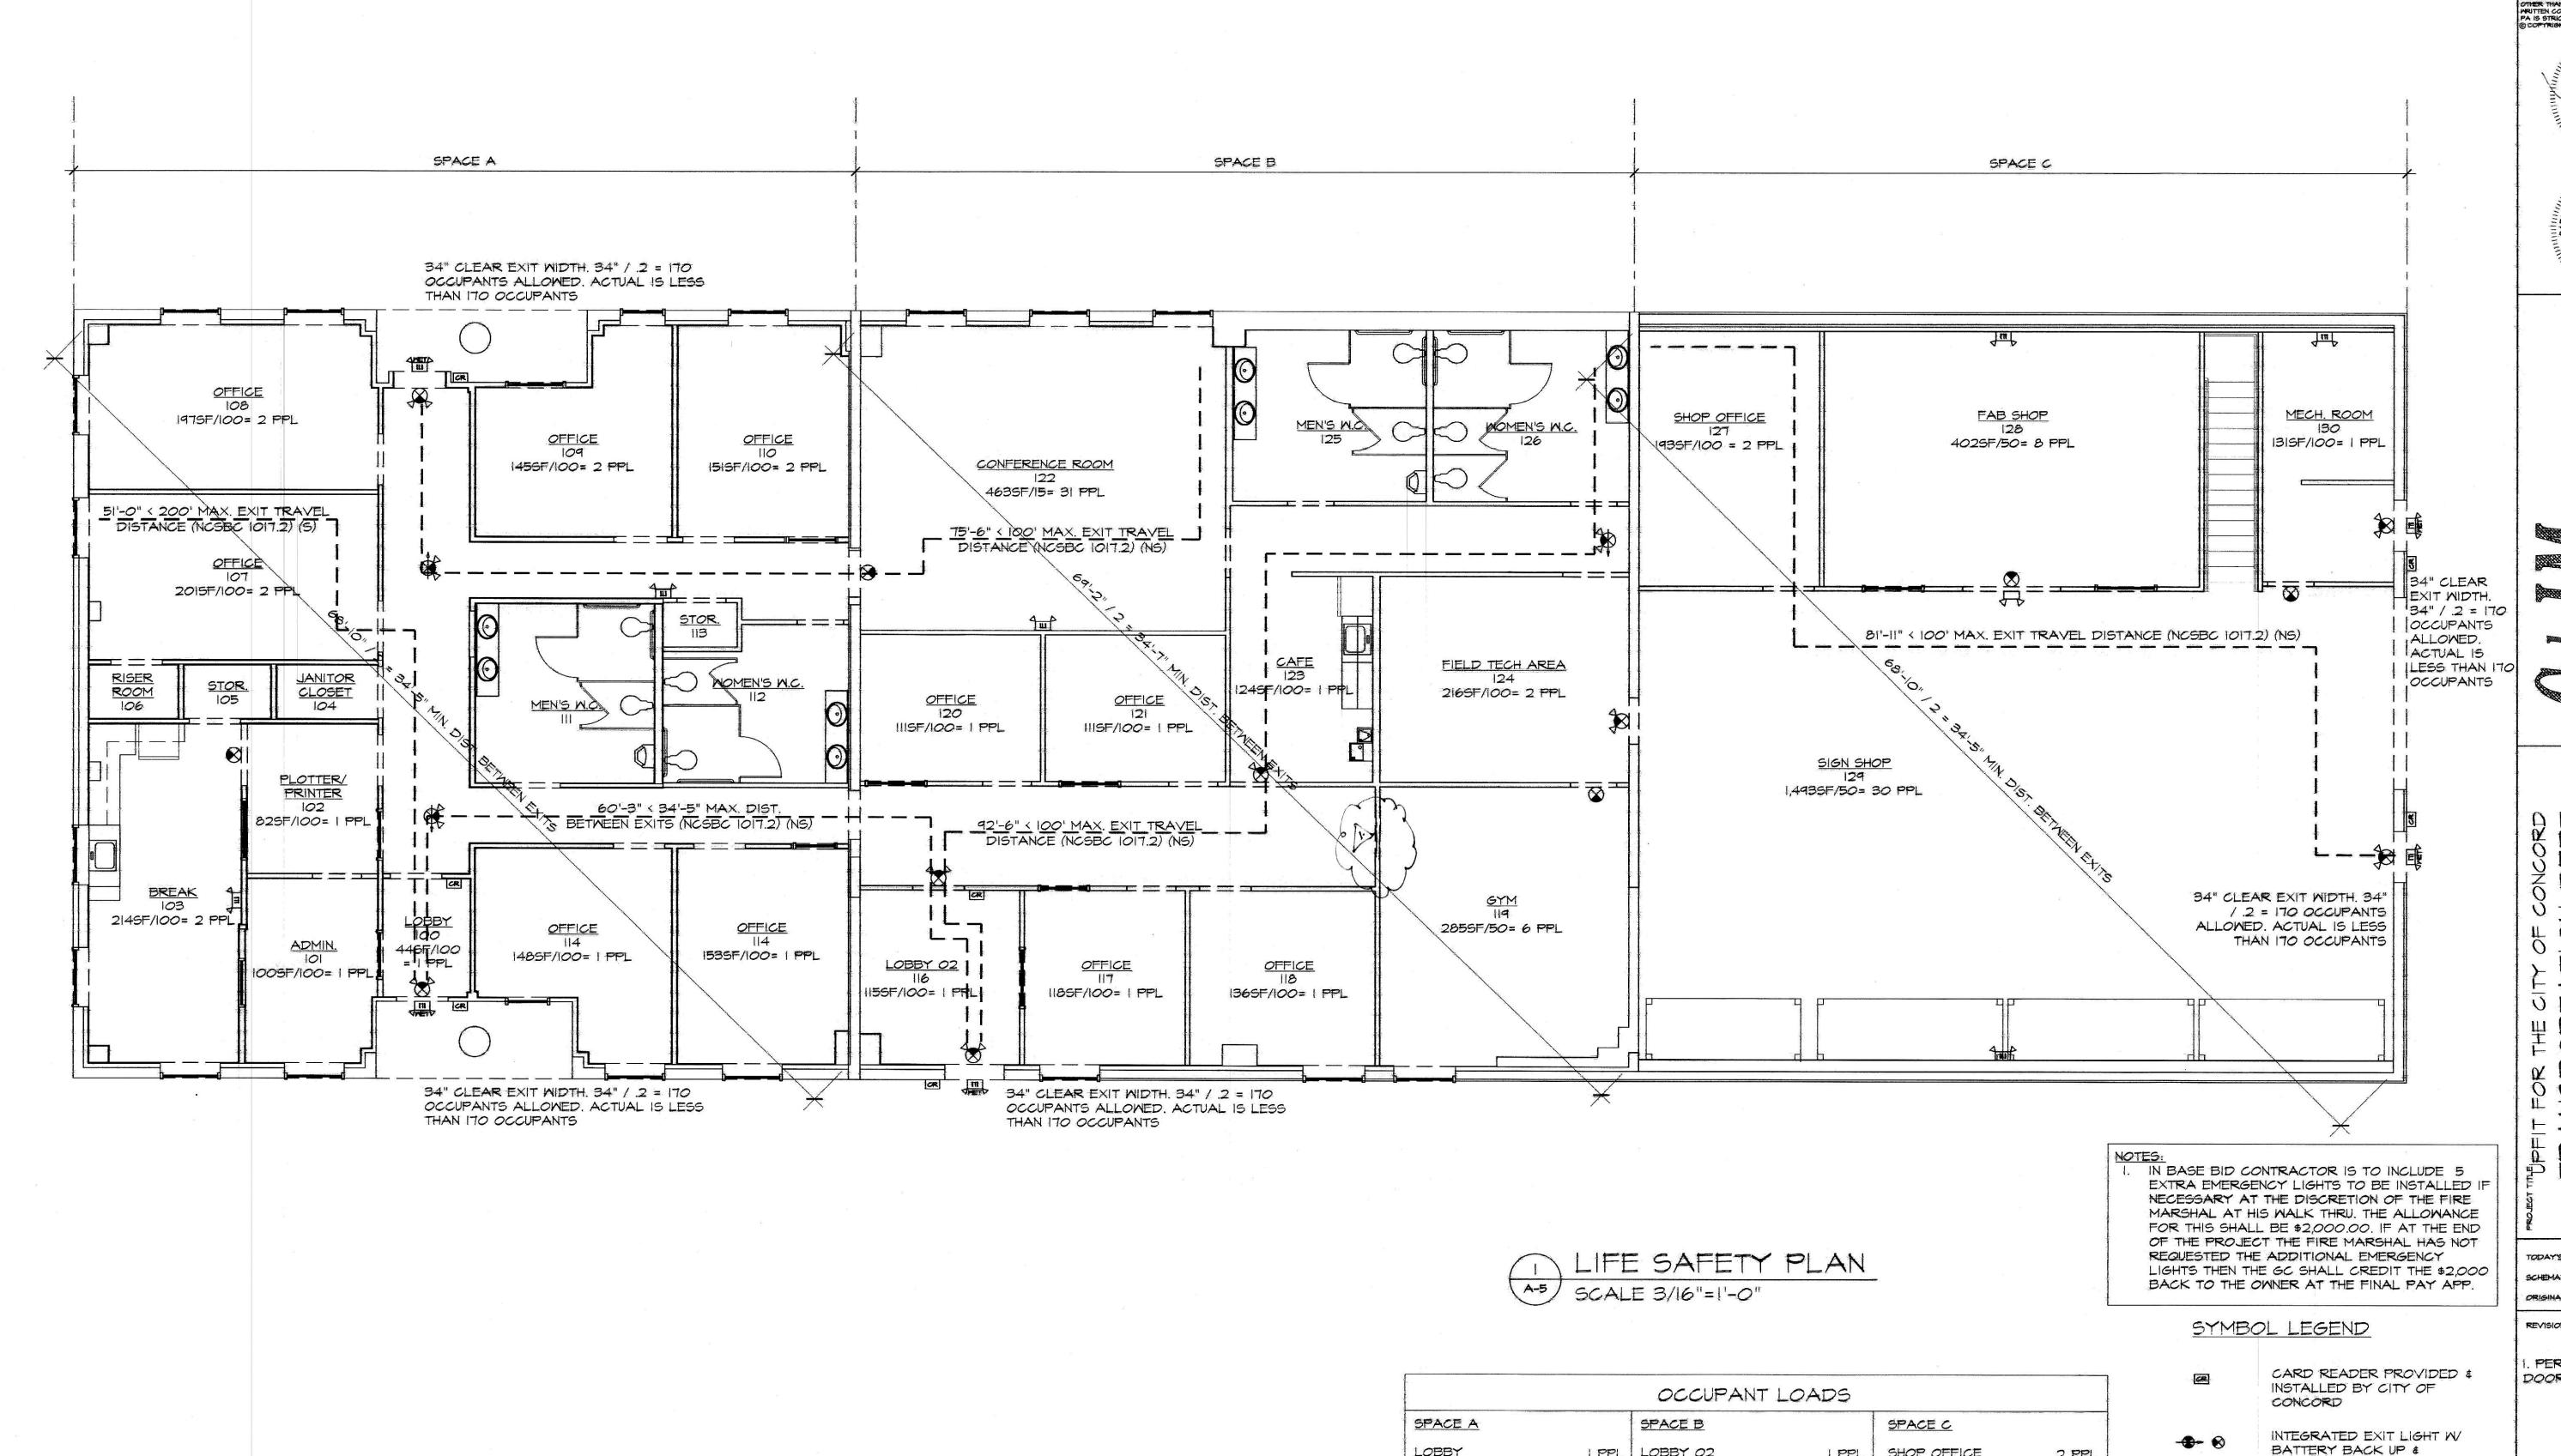

LOBBY

ADMIN.

BREAK

TOTAL

PLOTTER / PRINTER

OFFICE (107 - 114)

LOBBY 02

I PPL CONFERENCE ROOM

10 PPL | FIELD TECH AREA

CAFE

2 PPL GYM

15 PPL TOTAL

OFFICE (117, 118, 120, 121)

TOTAL OCCUPANT LOAD : 101 PPL

SHOP OFFICE

FAB SHOP

6 PPL MECH. ROOM

TOTAL

31 PPL | SIGN SHOP

2 PPL

8 PPL

30 PPL

41 PPL

1 PPL

I PPL

4 PPL

2 PPL

1 PPL

45 PPL

CORE ARCH CERT. NO. 51212 ONCORD, N 1 8 P

TODAY'S DATE: 09.14.2021 SCHEMATIC DESIGN APPR: XXX ORIGINAL SEAL DATE: 09.10.2021

09.14.2021 PER OWNER DELETED DOOR 19A

DRAWING NUMBER: 210805 LS DRAWN BY: RGW/DCOK PROJECT MGR: VLM

DIRECTIONAL SIGNAGE AS

INTEGRATED EXIT/EMERGENCY

LIGHT W/ BATTERY BACK UP \$

EMERGENCY DUAL HEAD W/90

EMERGENCY LIGHT W/ BATTERY

DIRECTIONAL SIGNAGE AS

MIN, W/ BATTERY BACK-UP

BACK UP, WET LABEL

REQUIRED

REQUIRED

CHECKED BY: V. MOORE · = =

TOTAL * OF

					DOO	R SC	HEDUL	E ACCESS	ONTROL COM	CITY OF CONCORD. YPANY TO PREP EXISTING PREP ANY PROPOSED DOORS. SHALL BE ADA COMPLIANT
	DOOR #	SIZE	DOOR ELEV.	DOOR TYPE	FRAME TYPE	HDW SET #	RATED	PANIC HDW	ACCESS CONTROL	REMARKS
	100A	EXISTING	EXIST	EXIST	EXIST				YES	
	100B	EXISTING	EXIST	EXIST	EXIST		Jane State onto		YES	
	1000	EXISTING	EXIST	EXIST	EXIST				YES	
	102	3070 X 3/4"	C	5.C. WD.						BARN DOOR KIT
	108	3070 x 3/4"	Α	S.C. WD.	нм.	#1	. A <u> </u>			
	111	3070 × 1 3/4"	В	S.C. WD.	H.M.	#2				
	. 112	3070 × 1 3/4"	B	5.C. MD.	H.M.	#2				
	113	3070 × 1 3/4"	Α	S.C. ND.	н.м.	#3				
	116A	3070 x 1 3/4"	Α	5.C. ND.	н.м.	#4		YES	YES	
	II6B	3070 x 1 3/4"	D	н.м.	Н.М.	#5		YES	YES	SIDELIGHT
	118	3070 x 3/4"	Α	S.C. ND.	H.M.	#1		ì		
A	{ HAA }	3070 x 1 3/4"	service decisión en en en exercica	5.C. ND.	H.M.	***				
	IIAB	3070 × 1 3/4"	A	S.C. ND.	н.м.	#6				
	122A	3070 x 1 3/4"	Α	S.C. ND.	н.м.	#7			-	
	122B	3070 × 1 3/4"	A	S.C. ND.	H.M.	#7				
	125	3070 x 1 3/4"	В	S.C. ND.	H.M.	#2				
	126	3070 × 1 3/4"	В	S.C. ND.	н.м.	#2				
	127	3070 x 3/4"	Α	S.C. WD.	н.м.	#7	apin may year			
	128	PR 3070 X 3/4	E	H.M.	н.м.	#8			i i	
	129A	3070 × 1 3/4"	А	S.C. ND.	H.M.	#9				
	129B	3070 × 1 3/4"	D	н.м.	н.м.	#5		YES	YES	
	130	3070 x 3/4"	D	н.м.	H.M.	#7				in the state of th


TOILET ACCESSORIES SCHEDULE


FIXTURE / ACCESSORY:	MFG / MODEL #/COLOR
36" GRAB BAR	AMERICAN SPECIALTIES INC / ALPACO
42" GRAB BAR	AMERICAN SPECIALTIES INC / TYPE OI
8" GRAB BAR	AMERICAN SPECIALTIES INC / TYPE OI
18" X 36" ADA FIXED TILT MIRROR	BOBRICK B-293 1836
18" X 30" ADA FIXED TILT MIRROR	BOBRICK B-293 1830
SOAP DISPENSER (BY CITY)	GOJO LTX-12 1200 ML TOUCH FREE
RECESSED PAPER TOWEL DISPENSER & WASTE RECEPTICLE (BY CITY)	BOBRICK B-3947
SURFACE MOUNTED DOUBLE ROLL TOILET TISSUE DISPENSER (BY CITY)	BOBRICK B-27460

ROOM FINISH SCHEDULE

ALL SPECIFICATION/	ARE	"BASIS	OF	DESIGN."
SELECTIONS.				

ROOM NAME	ROOM #	FLOOR	BASE	SOUND BATTS	MALLS	WALL FINISH		0	EILING	DEMARKS	
						MANUFACTURER	COLOR/SKU	TYPE	HGT.	REMARKS	
LOBBY I	100	LVT	ROPPE 700 SERIES		EXISTING/GMB	SHERMIN MILLIAMS	SW7663	2×2 LAY-IN	EXISTING	I. ALL CARPET TO BE	
ADMIN	101	CARPET	ROPPE 700 SERIES		EXISTING/GMB	SHERWIN WILLIAMS	SWT663	2x2 LAY-IN	EXISTING	CATALYST SERIES 18-	
PRINTER/PLOTTER	102	LVT	ROPPE 700 SERIES		EXISTING/GMB	SHERWIN WILLIAMS	SW7663	2×2 LAY-IN	EXISTING	2847).	
BREAK AREA	103	LVT	ROPPE 700 SERIES		EXISTING	SHERWIN WILLIAMS	SW7663	2x2 LAY-IN	EXISTING	2. ALL BASE TO BE ROPPE 700 SERIES 4	
JANITOR'S CLOSET	104	LVT	ROPPE 700 SERIES		EXISTING	SHERWIN WILLIAMS	5MT663	2×2 LAY-IN	EXISTING	X 1/8" THICK RUBBER BASE (COLOR: PEWTER	
STORAGE	105	LVT	ROPPE 700 SERIES		EXISTING	SHERWIN WILLIAMS	SW7663	2x2 LAY-IN	EXISTING	OR EQUIVALENT.	
RISER ROOM	106	LVT	ROPPE TOO SERIES		EXISTING	SHERWIN WILLIAMS	SM7663	2x2 LAY-IN	EXISTING	3. ALL LVT TO BE J+. FLOORING ALLOY	
OFFICE	107	CARPET	ROPPE 700 SERIES	i s	EXISTING/GMB	SHERWIN WILLIAMS	SW7663	2x2 LAY-IN	EXISTING	SERIES V5008 (PATTERN: COMPOUND	
OFFICE	108	CARPET	ROPPE 700 SERIES		EXISTING/GMB	SHERWIN WILLIAMS	SW7663	2x2 LAY-IN	EXISTING	1052)	
OFFICE	109	LVT	ROPPE 700 SERIES		EXISTING	SHERWIN WILLIAMS	SW7663	2×2 LAY-IN	EXISTING	4. ALL DOOR TRIM TO BE PAINTED W SHERE	
OFFICE	110	LVT	ROPPE 100 SERIES		EXISTING	SHERWIN WILLIAMS	SM7663	2x2 LAY-IN	EXISTING	WILLIAMS HIGH REFLECTIVE WHITE	
MEN'S W.C.	III .	12X24 TILE	ROPPE TOO SERIES	YES	M.R. GMB/ C.T	FLOOR DECOR & MORE	100136795	2x2 LAY-IN	8'-O"	SW7557.	
MOMEN'S M.C.	112	12X24 TILE	ROPPE TOO SERIES	YES	M.R. GMB/ C.T	FLOOR DECOR & MORE	100136795	2x2 LAY-IN	EXISTING	5. ALL TILE FLOORING TO BE CONCRETE GR	
STORAGE	113	LVT	ROPPE TOO SERIES		M.R. GWB	SHERWIN WILLIAMS	SW7663	5/8" GMB	EXISTING	CERAMIC TILE 12"X24 (FLOOR DECOR \$	
OFFICE	114	CARPET	ROPPE TOO SERIES		EXISTING	SHERWIN WILLIAMS	SMT663	2×2 LAY-IN	EXISTING	MORE: 100136795) W/DARK GREY GROUT.	
OFFICE	115	CARPET	ROPPE TOO SERIES		EXISTING/GWB	SHERMIN MILLIAMS	SW7663	2×2 LAY-IN	EXISTING	6. ALL EXISTING GMB	
LOBBY 2	116	LVT	ROPPE 700 SERIES	YES	EXISTING/GMB	SHERWIN WILLIAMS	SM7663	2x2 LAY-IN	8'-0"	WALLS TO BE PAINTE WITH SWT663.	
OFFICE	117	CARPET	ROPPE TOO SERIES	YES	EXISTING/GMB	SHERWIN WILLIAMS	SM7663	2x2 LAY-IN	8'-0"	7. RUBBER FLOOR TO	
OFFICE	118	CARPET	ROPPE TOO SERIES	YES	EXISTING/GMB	SHERWIN WILLIAMS	SW7663	2x2 LAY-IN	8¹-O"	BE FISHMAN PRODUCT	
GYM	119	RUBBER FLOOR	ROPPE 700 SERIES	YES	EXISTING/GMB	SHERWIN WILLIAMS	SM7663	EXISTING	EXISTING	(COLOR:BLACK).	
OFFICE	120	CARPET	ROPPE 700 SERIES	YES	EXISTING/GMB	SHERWIN WILLIAMS	SW7663	2x2 LAY-IN	EXISTING		
OFFICE	121	CARPET	ROPPE TOO SERIES	YES	EXISTING/M.R. GWB	SHERMIN MILLIAMS	SM7663	2x2 LAY-IN	EXISTING		
CONF. ROOM	122	CARPET	ROPPE 700 SERIES	YES	EXISTING/GMB	SHERWIN WILLIAMS	SW7663	2x2 LAY-IN	8'-0"		
CAFE KITCHEN	123	LVT	ROPPE 700 SERIES	YES	EXISTING/GWB	SHERWIN WILLIAMS	SM7663	2×2 LAY-IN	8'-0"		
FIELD TECH AREA	124	LVT	ROPPE TOO SERIES	1	EXISTING/GWB	SHERWIN WILLIAMS	SW7663	2×2 LAY-IN	8'-0"		
MEN'S W.C.	125	I2X24 TILE	ROPPE TOO SERIES	YES	M.R. GNB/ C.T	FLOOR DECOR & MORE	100136795	2x2 LAY-IN	8'-0"		
MOMEN'S M.C.	126	12X24 TILE	ROPPE TOO SERIES	YES	M.R. GWB/ C.T	FLOOR DECOR # MORE	100136795	2×2 LAY-IN	8'-0"		
SHOP OFFICE	127	LVT	ROPPE 700 SERIES		EXISTING/M.R. GWB	SHERWIN WILLIAMS	SW7663	2×2 LAY-IN	EXPOSED	AT SETTLED AREA	
FAB SHOP	128	LVT	ROPPE 700 SERIES		EXISTING/M.R. GNB	SHERWIN WILLIAMS	SM7663	2x2 LAY-IN	EXPOSED	AT CRACKS, GRINI SMOOTH & APPLY CRACK CHASER	
SIGN SHOP	129	EXISTING	ROPPE TOO SERIES		EXISTING/GMB	SHERWIN WILLIAMS	SM7663	EXISTING	EXISTING		
MECH. ROOM	130	EXISTING	ROPPE 700 SERIES	YES	EXISTING/GMB	SHERWIN WILLIAMS	SM7663	2x2 LAY-IN	8'-0"		
HALLWAY A	SPACE A	CARPET	ROPPE 700 SERIES		EXISTING/GMB	SHERWIN WILLIAMS	SW7663	2x2 LAY-IN	EXISTING		
HALLWAY B	SPACE B	CARPET	ROPPE 700 SERIES		EXISTING/GMB	SHERWIN WILLIAMS	SM7663	2x2 LAY-IN	EXISTING		

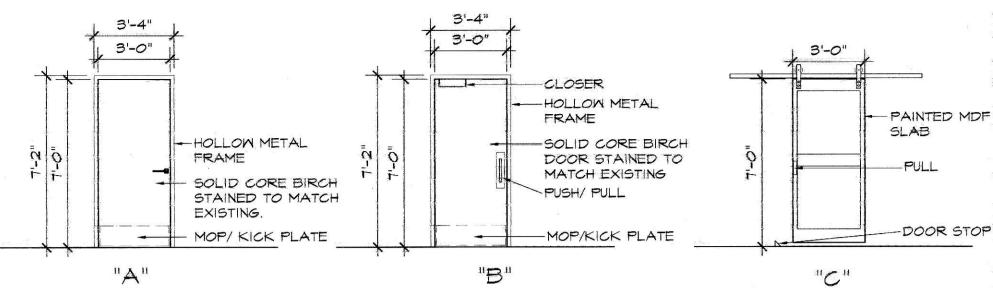

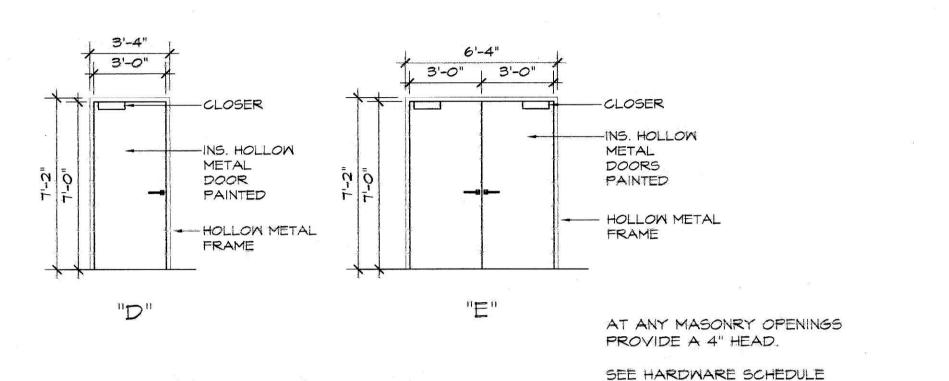

DOOR ELEVATIONS

A-6 SCALE 1/4"=1'-0"

HARDWARE SET #2 HARDWARE SET #3 HARDWARE SET #4 HARDWARE SET #5 HARDWARE SET #! 3 BUTTS 3 BUTTS 3 BUTTS 3 BUTTS SILENCERS WEATHERSTR PP NG SILENCERS PUSH/PULL SHENCERS LEVER HANDLES W/ LEVER HANDLES LEVER HANDLES DRIP CAP CLOSER W/ STORE ROOM MOP + KICK PLATES THRESHOLD OFFICE LOCK SILENCERS KICK PLATE/MOP LOCK CARD READER LEVER HANDLES WALL BUMPER CARD READER CLOSER MOP PLATE KICK PLATE PANIC DEVICE PANIC DEVICE HOLD DOWN HOLD DOWN ELECTRONIC STRIKE ELECTRONIC STRIKE PROVIDED BY CITY PROVIDED BY CITY HARDWARE SET #6 HARDWARE SET #7 HARDWARE SET #8 HARDWARE SET #9 3 BUTTS 3 BUTTS 3 BUTTS 6 BUTTS LEVER SILENCERS SILENCERS FLUSH BOLTS HEANDLES/PASSAGE LEVER HANDLE LEVER HANDLES W/ CLOSER OFFICE LOCK ALL DOOR HARDWARE LEVER HANDLES W/ OFFICE LOCK SHALL BE ADA COMPLIANT \$ SILENCES WALL BUMPER LOCK SET PROTECTION LEVER TYPE HANDLES MOP PLATE/KICK MOP PLATE/KICK MOP PLATE/ KICK PLATES PLATE PLATE PLATE


CARD READER


ELECTRONIC STRIKE PROVIDED BY CITY

2 DOOR HARDWARE SETS

FLOOR STOP

HOLD DOWN

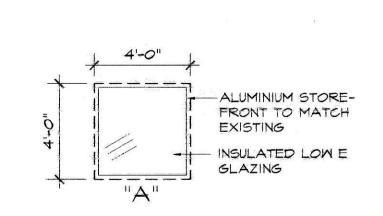

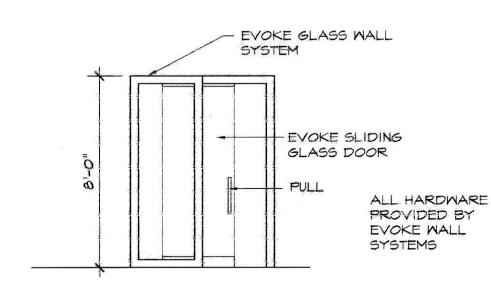

2. ALL HARDWARE TO BE

BRUSHED NICKEL

NOTICE:
ALL FEDERAL, STATE, LOCAL CODES, ORDINANCES AND REGULATIONS SHALL BE CONSIDERED AS PART OF PLANS AND SPECIFICATIONS FOR THIS BILLDING AND SHALL TAKE PREFERENCE OVER ANYTHING SHOWN, DESCRIBED OR IMPLIED WHERE VARIANCES OCCUR. THESE DRAWINGS ARE DIAGRAMMATIC, NOT INDICATING ALL CONDITIONS AND DETAILS, AND ARE INTENDED TO BE USED BY EXPERIENCED MECHANICS, EACH DRAWING IS COMPLEMENTARY TO THE OTHERS, ALL CONDITIONS AND DIMENSIONS MUST BE VERIFIED BY THE CONTRACTORS PRIOR TO INSTALLATION, WORK PERFORMED NOT IN COMPLIANCE WITH THE INTENT OF THESE DOCUMENTS ARE THE RESPONSIBILITY OF THE PERSONS PERFORMING THE WORK, LIMIT OF LIABILITY IS THE AMOUNT OF FEE CHARGED. THIS DRAMINS AND THE INFORMATION THEREON IS THE PROPERTY OF CARLOS MOORE, ARCHITECT, ANY REPRODUCTION, ALTERATION, OR USE FOR OTHER THAN THE INTENDED PROJECT, WITHOUT THE WRITTEN CONSENT OF CARLOS MOORE, IS STRICTLY FORBIDDEN. C) COPYRIGHT 2021 CARLOS MOORE, ARCHITECT PA CERT. NO. 51212 TOPTH CAROLINA CONCORD.

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TRANSPORTATION DE SENERAL SERVICES DR, CO の下市ワリ 242 TODAY'S DATE: 09.14.2021


SCHEMATIC DESIGN APPR: XXX ORIGINAL SEAL DATE: 09.10.202

09.14.2021 PER OWNER DELETED DOOR 19A


DRAWING #: 210805 SCH DRAWN BY: RGW PROJECT MGR: VLM CHECKED BY: V. MOORE

SHEET +=10

I. CONTRACTOR TO PROVIDE ADEQUATE BLOCKING AS REQUIRED FOR ALL TOILET ACCESSORIES. 2. ALL MOUNTING HEIGHTS SHALL MEET ANSI, ADA AND NORTH CAROLINA CODE REQUIREMENTS. 3. ALL ACCESSIBLE LAVATORIES TO RECEIVE WATER AND DRAIN PIPE PROTECTION IF EXPOSED.

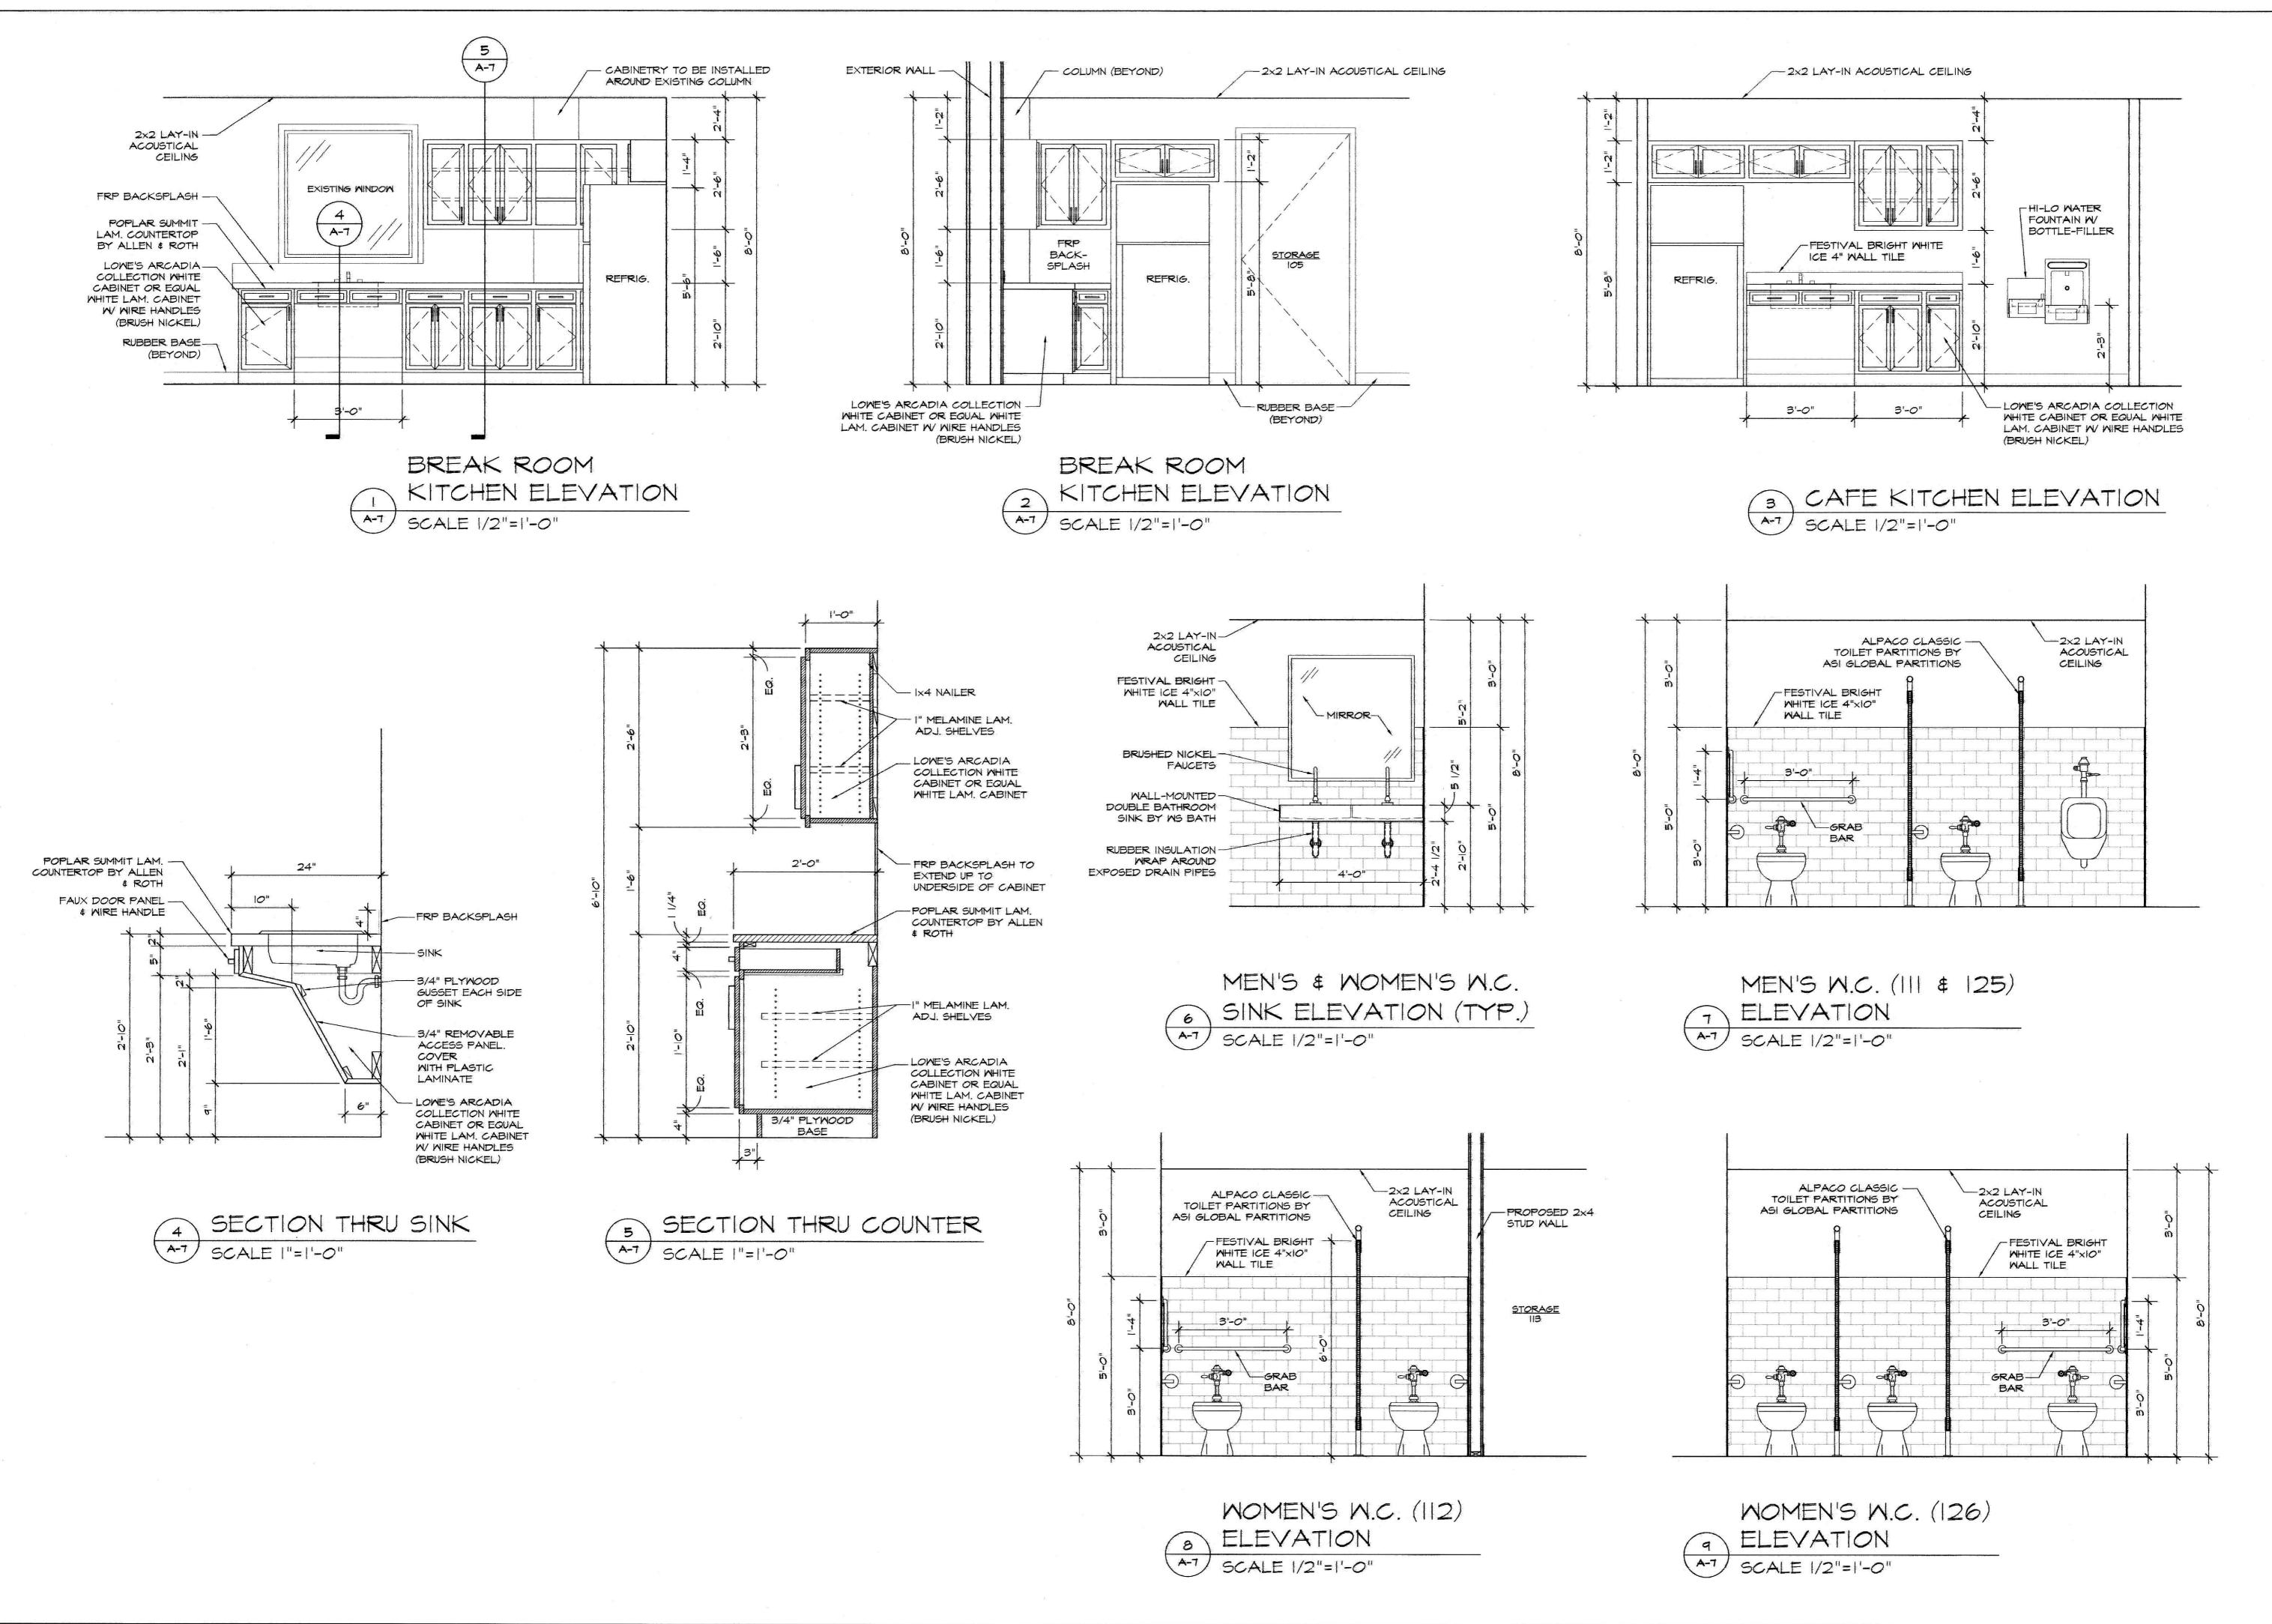

NOTICE:
ALL FEDERAL, STATE, LOCAL CODES, ORDINANCES AND RESULATIONS SHALL BE CONSIDERED AS PART OF PLANS AND SPECIFICATIONS FOR THIS BUILDING AND SHALL TAKE PREFERENCE OVER ANYTHING SHOWN, DESCRIBED OR IMPLIED WHERE VARIANCES OCCUR.
THESE DRAWINGS ARE DIAGRAMMATIC, NOT INDIGATING ALL CONDITIONS AND DETAILS, AND ARE INTENDED TO BE USED BY EXPERIENCED MECHANICS, EACH DRAWING IS COMPLEMENTARY TO THE OTHERS, ALL CONDITIONS AND DIMENSIONS MUST BE VERIFIED BY THE CONTRACTORS THROW TO INSTALLATION, WORK PERFORMED NOT IN COMPLIANCE WITH THE INTENT OF THESE DOCUMENTS ARE THE RESPONSIBILITY OF THE PERSONS PERFORMING THE WORK LIMIT OF LIABILITY IS THE ANCANT OF FEE CHARSED. THIS DRAWING AND THE INFORMATION THEREON IS THE PROPERTY OF CARLOS MOORE, ARCHITECT. ANY REPRODUCTION, ALTERATION, OR USE FOR OTHER THAN THE INTENDED PROJECT, WITHOUT THE WITTHEN CONSENT OF CARLOS MOORE, IS STRICTLY FORBIDDEN.

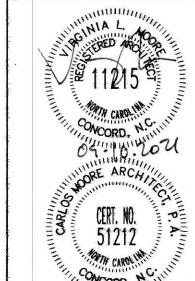

EST. 1987

ARCHITECT PA

ST. N. CONCORD, NC 28025

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ION DEPT.

DR. CONCORD, NC

VATIONS

T-10

142 GENERAL SERVICES DR. CONCO

TODAY'S DATE: O9.10.2021
SCHEMATIC DESIGN APPR. XXX

SCHEMATIC DESIGN APPR: XXX

ORIGINAL SEAL DATE: XXXXXX

REVISIONS:

REVISIONS:

DRAMING #: 210805 IE


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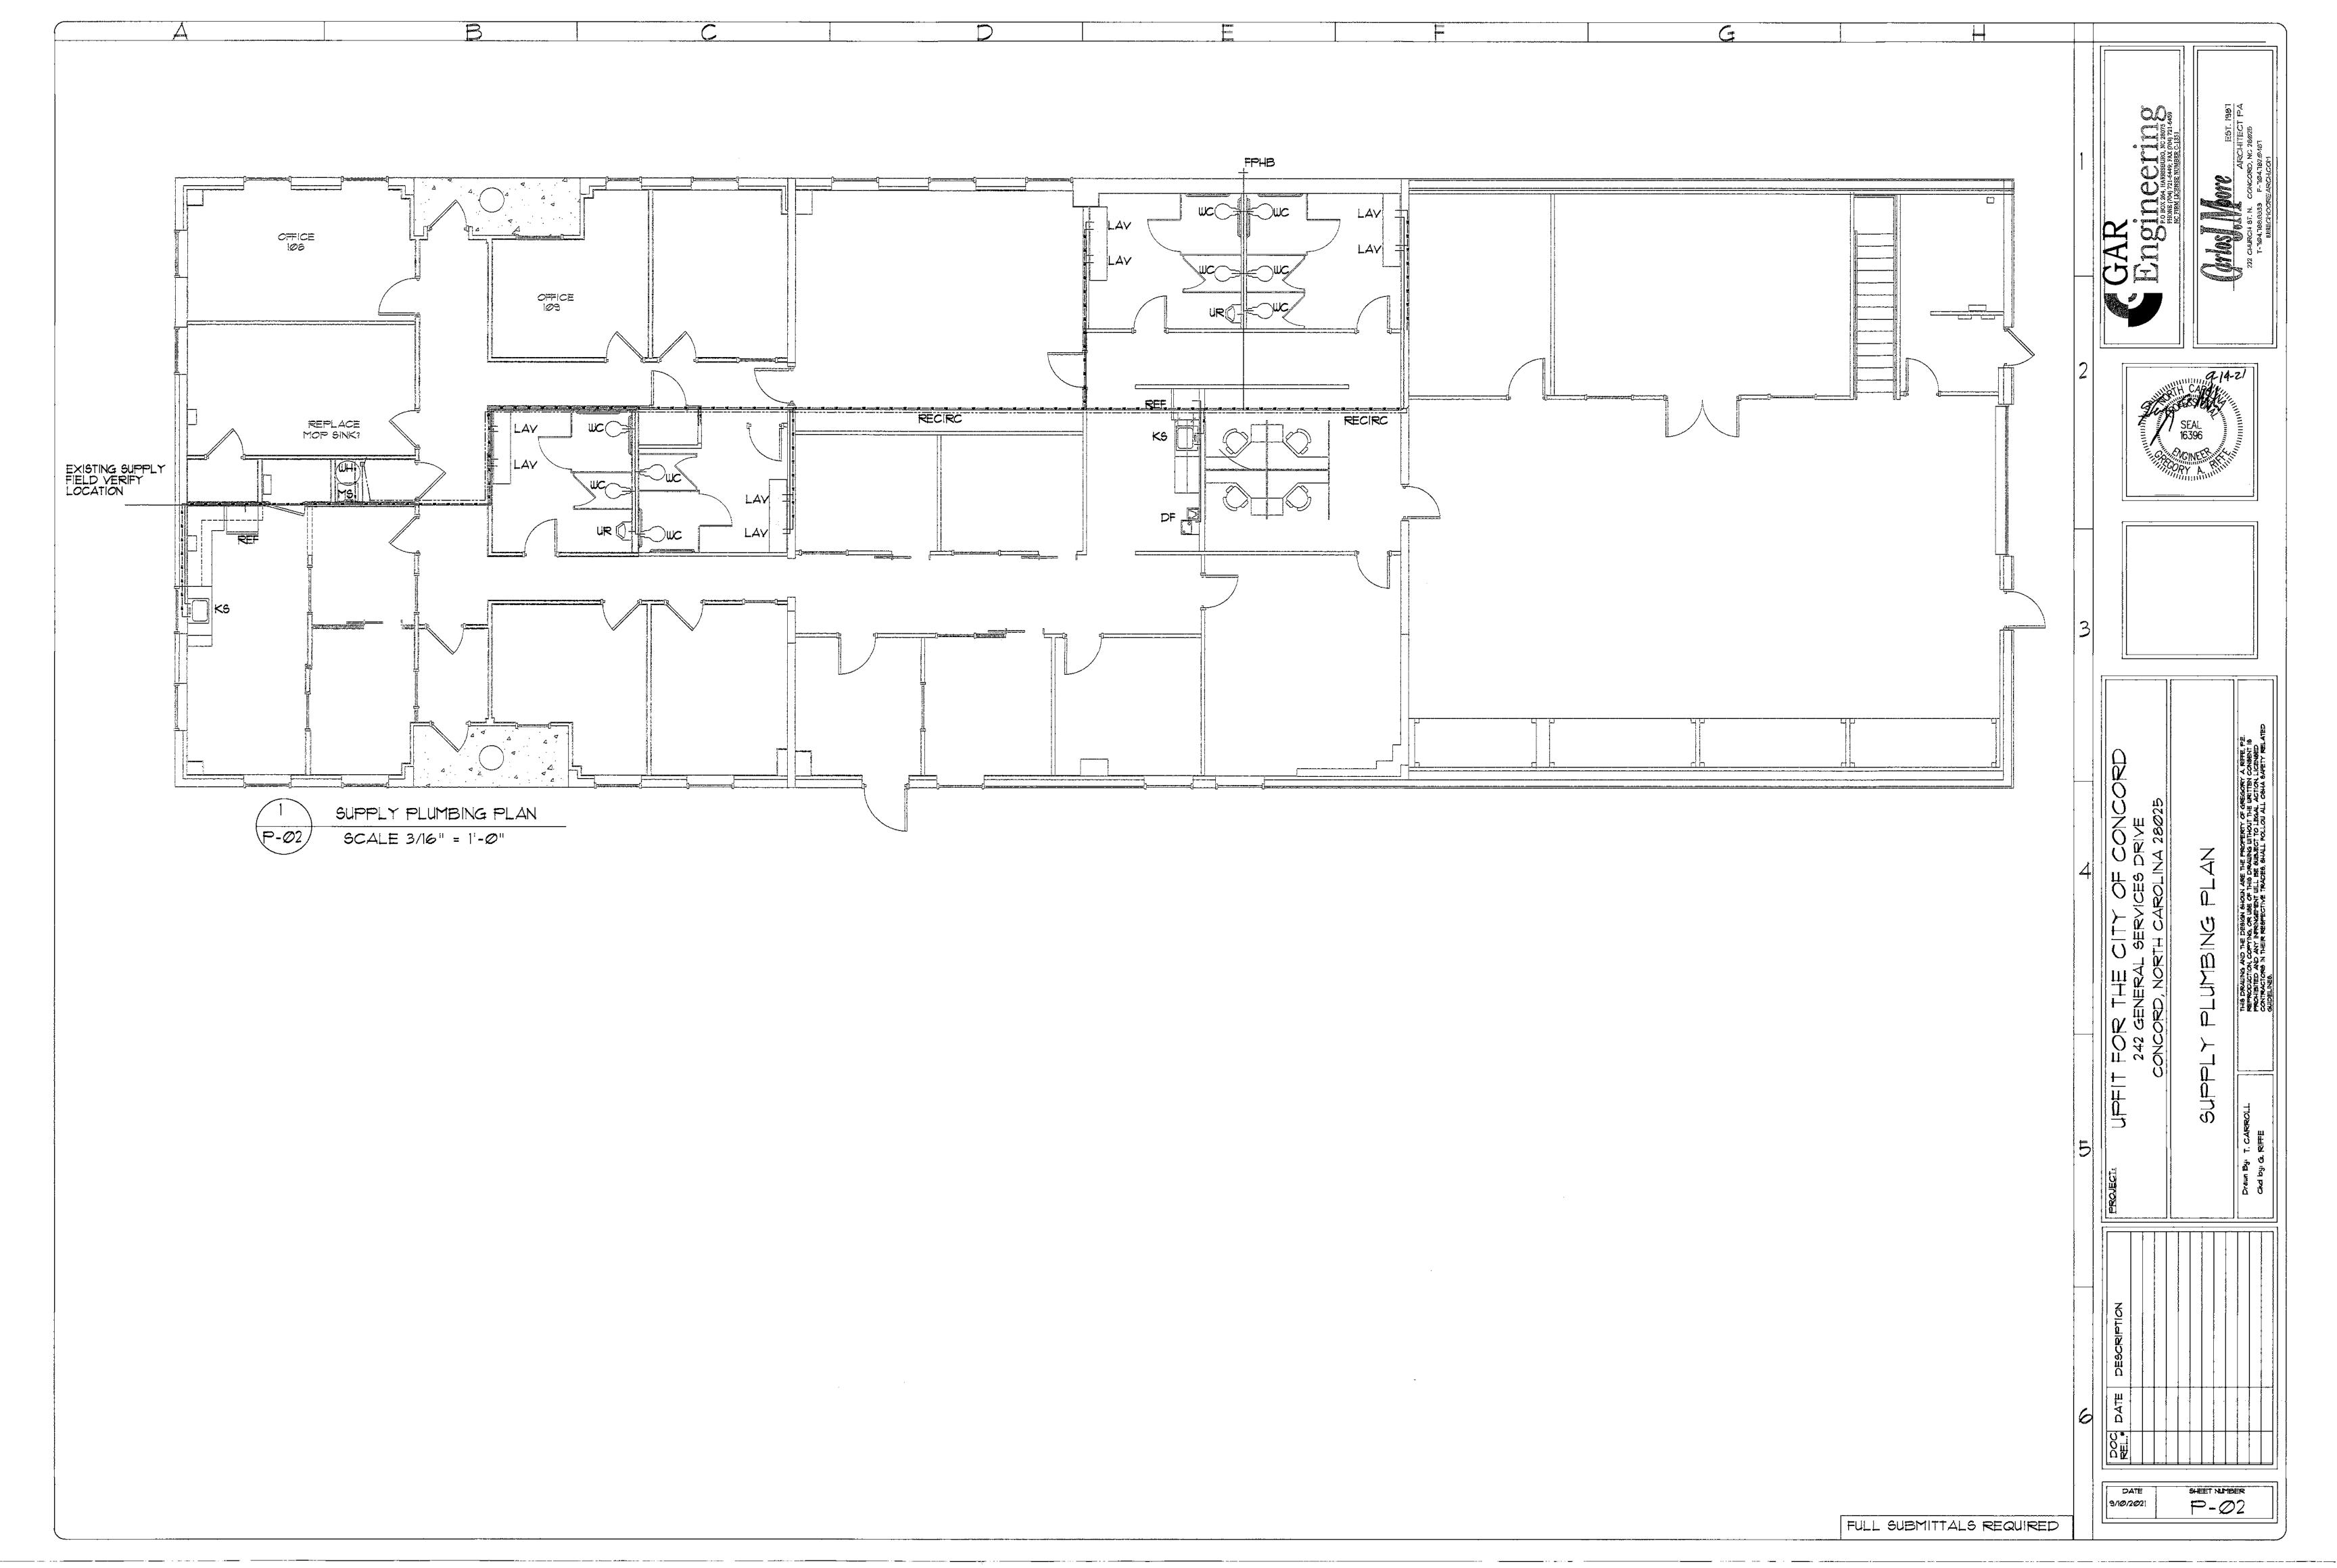
PROJECT MGR: VLM


CHECKED BY: V. MOORE


A= #

TOTAL # OF SHEETS: 28



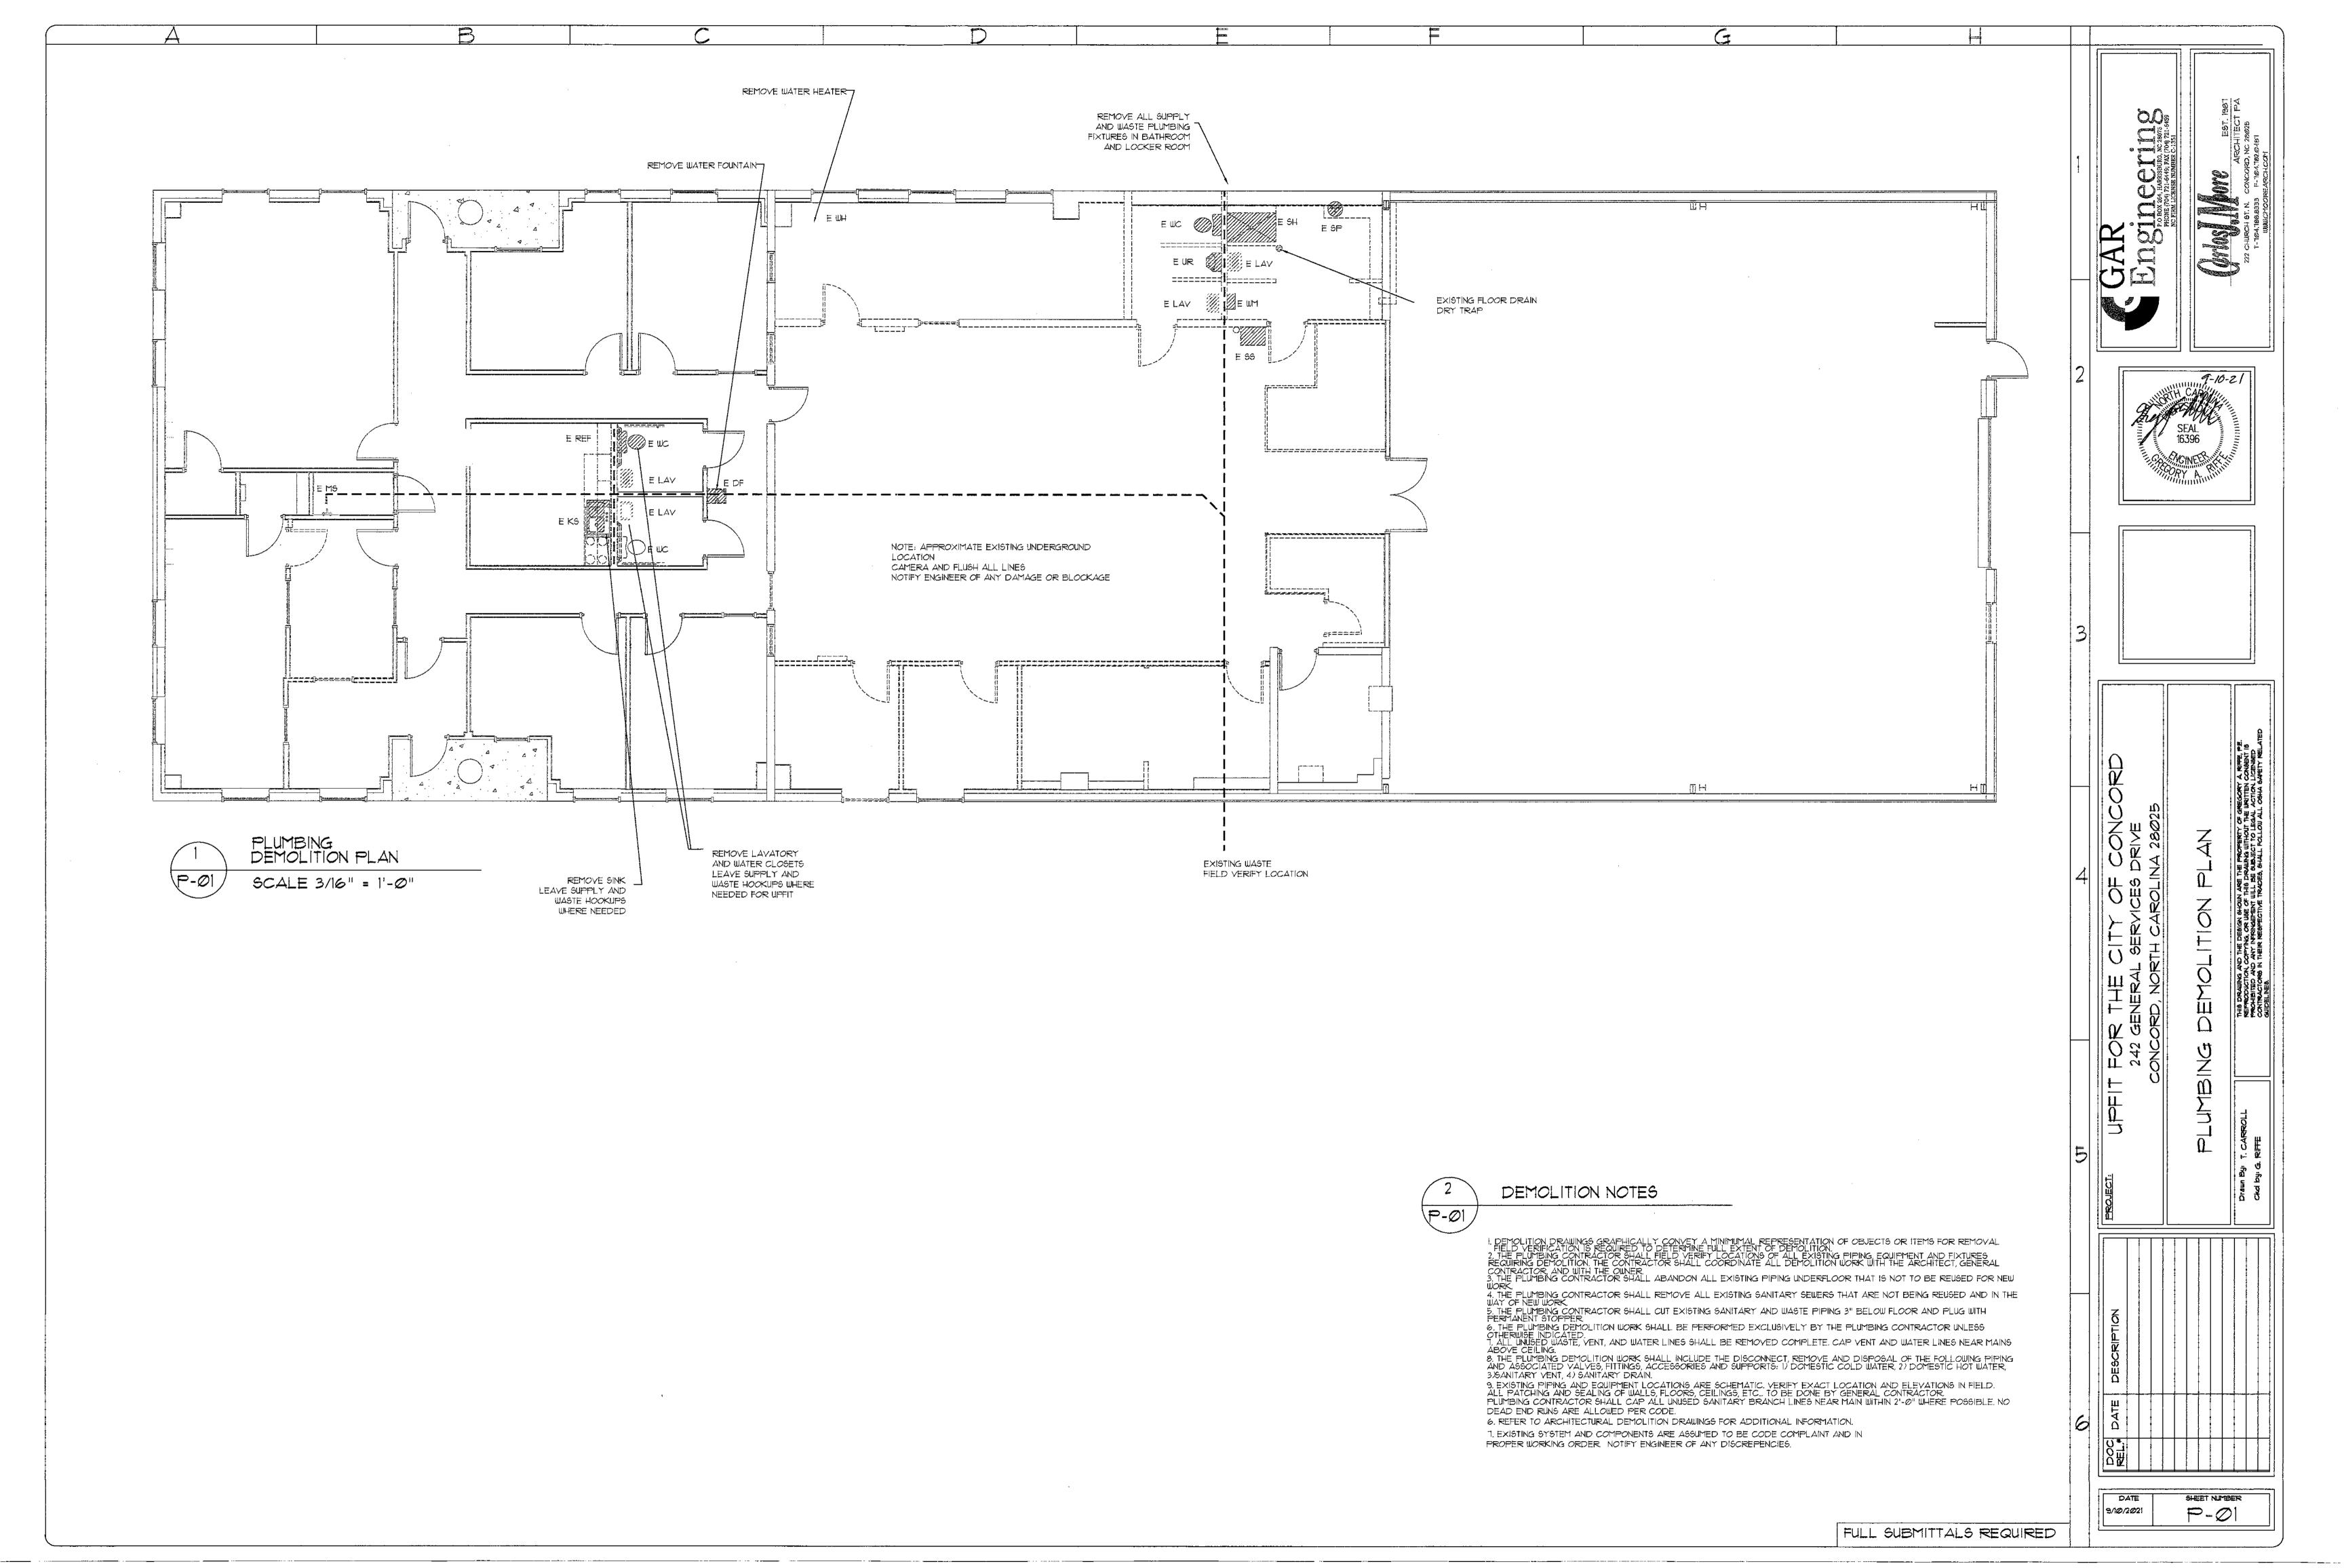

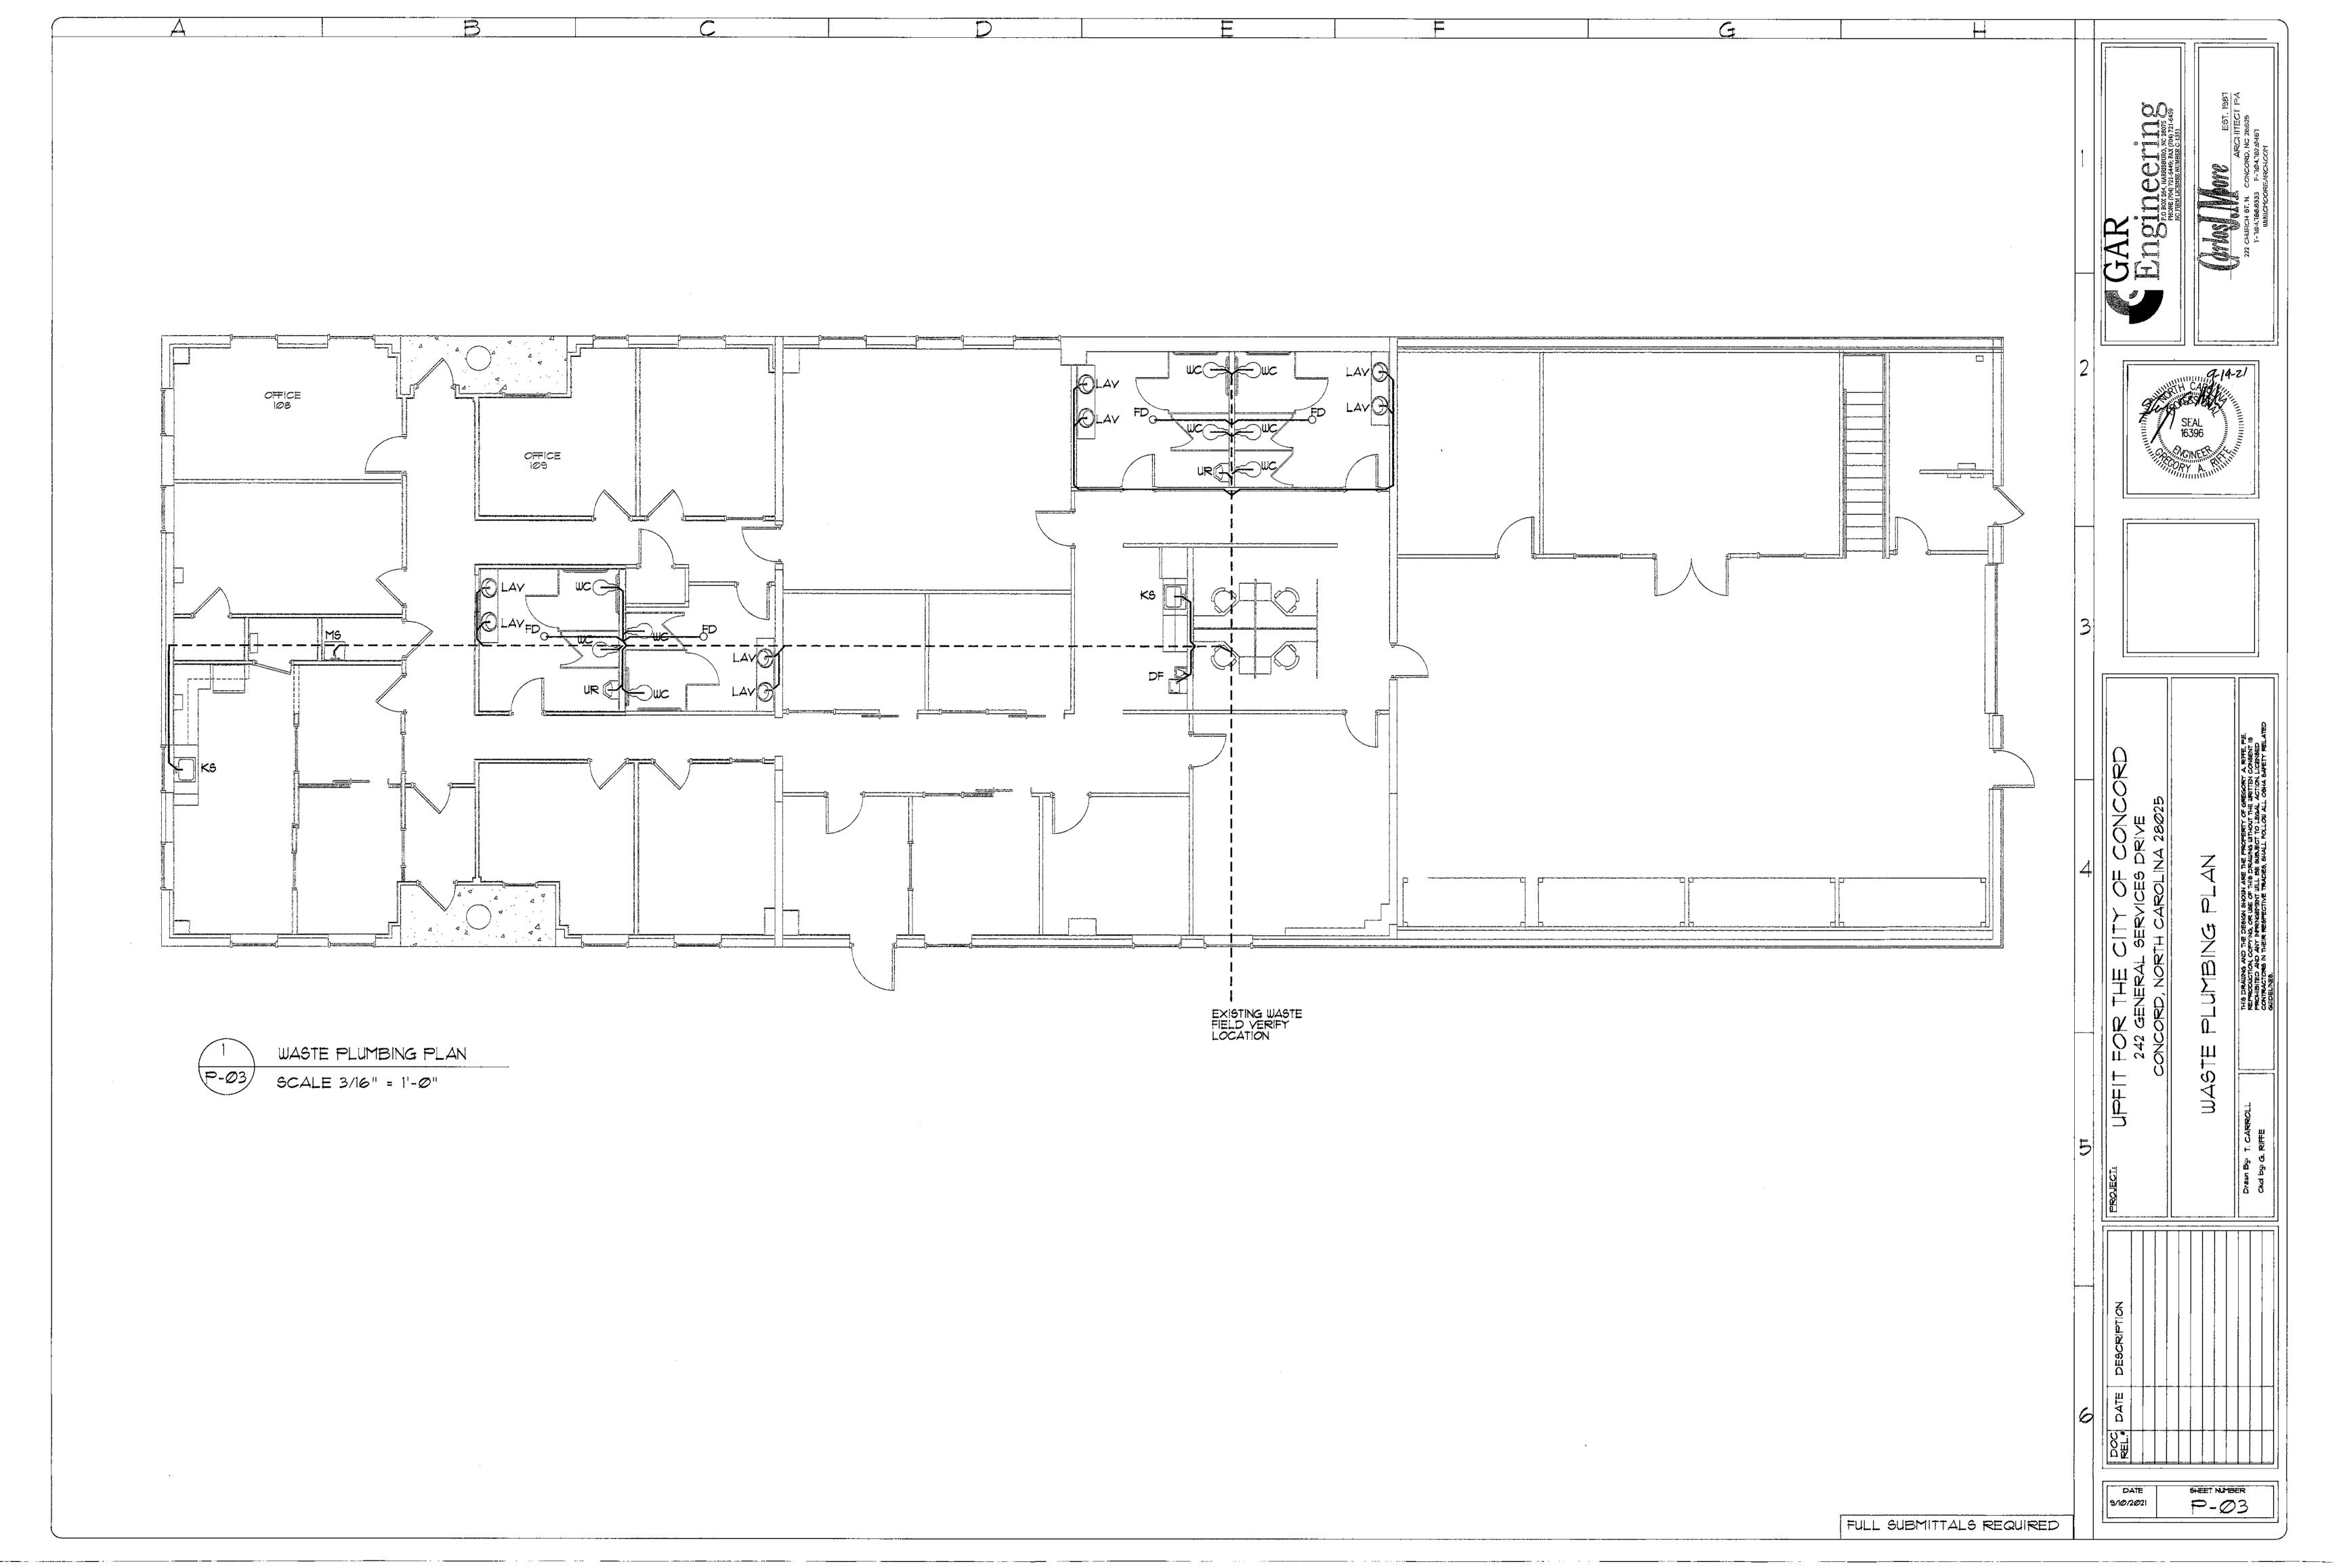

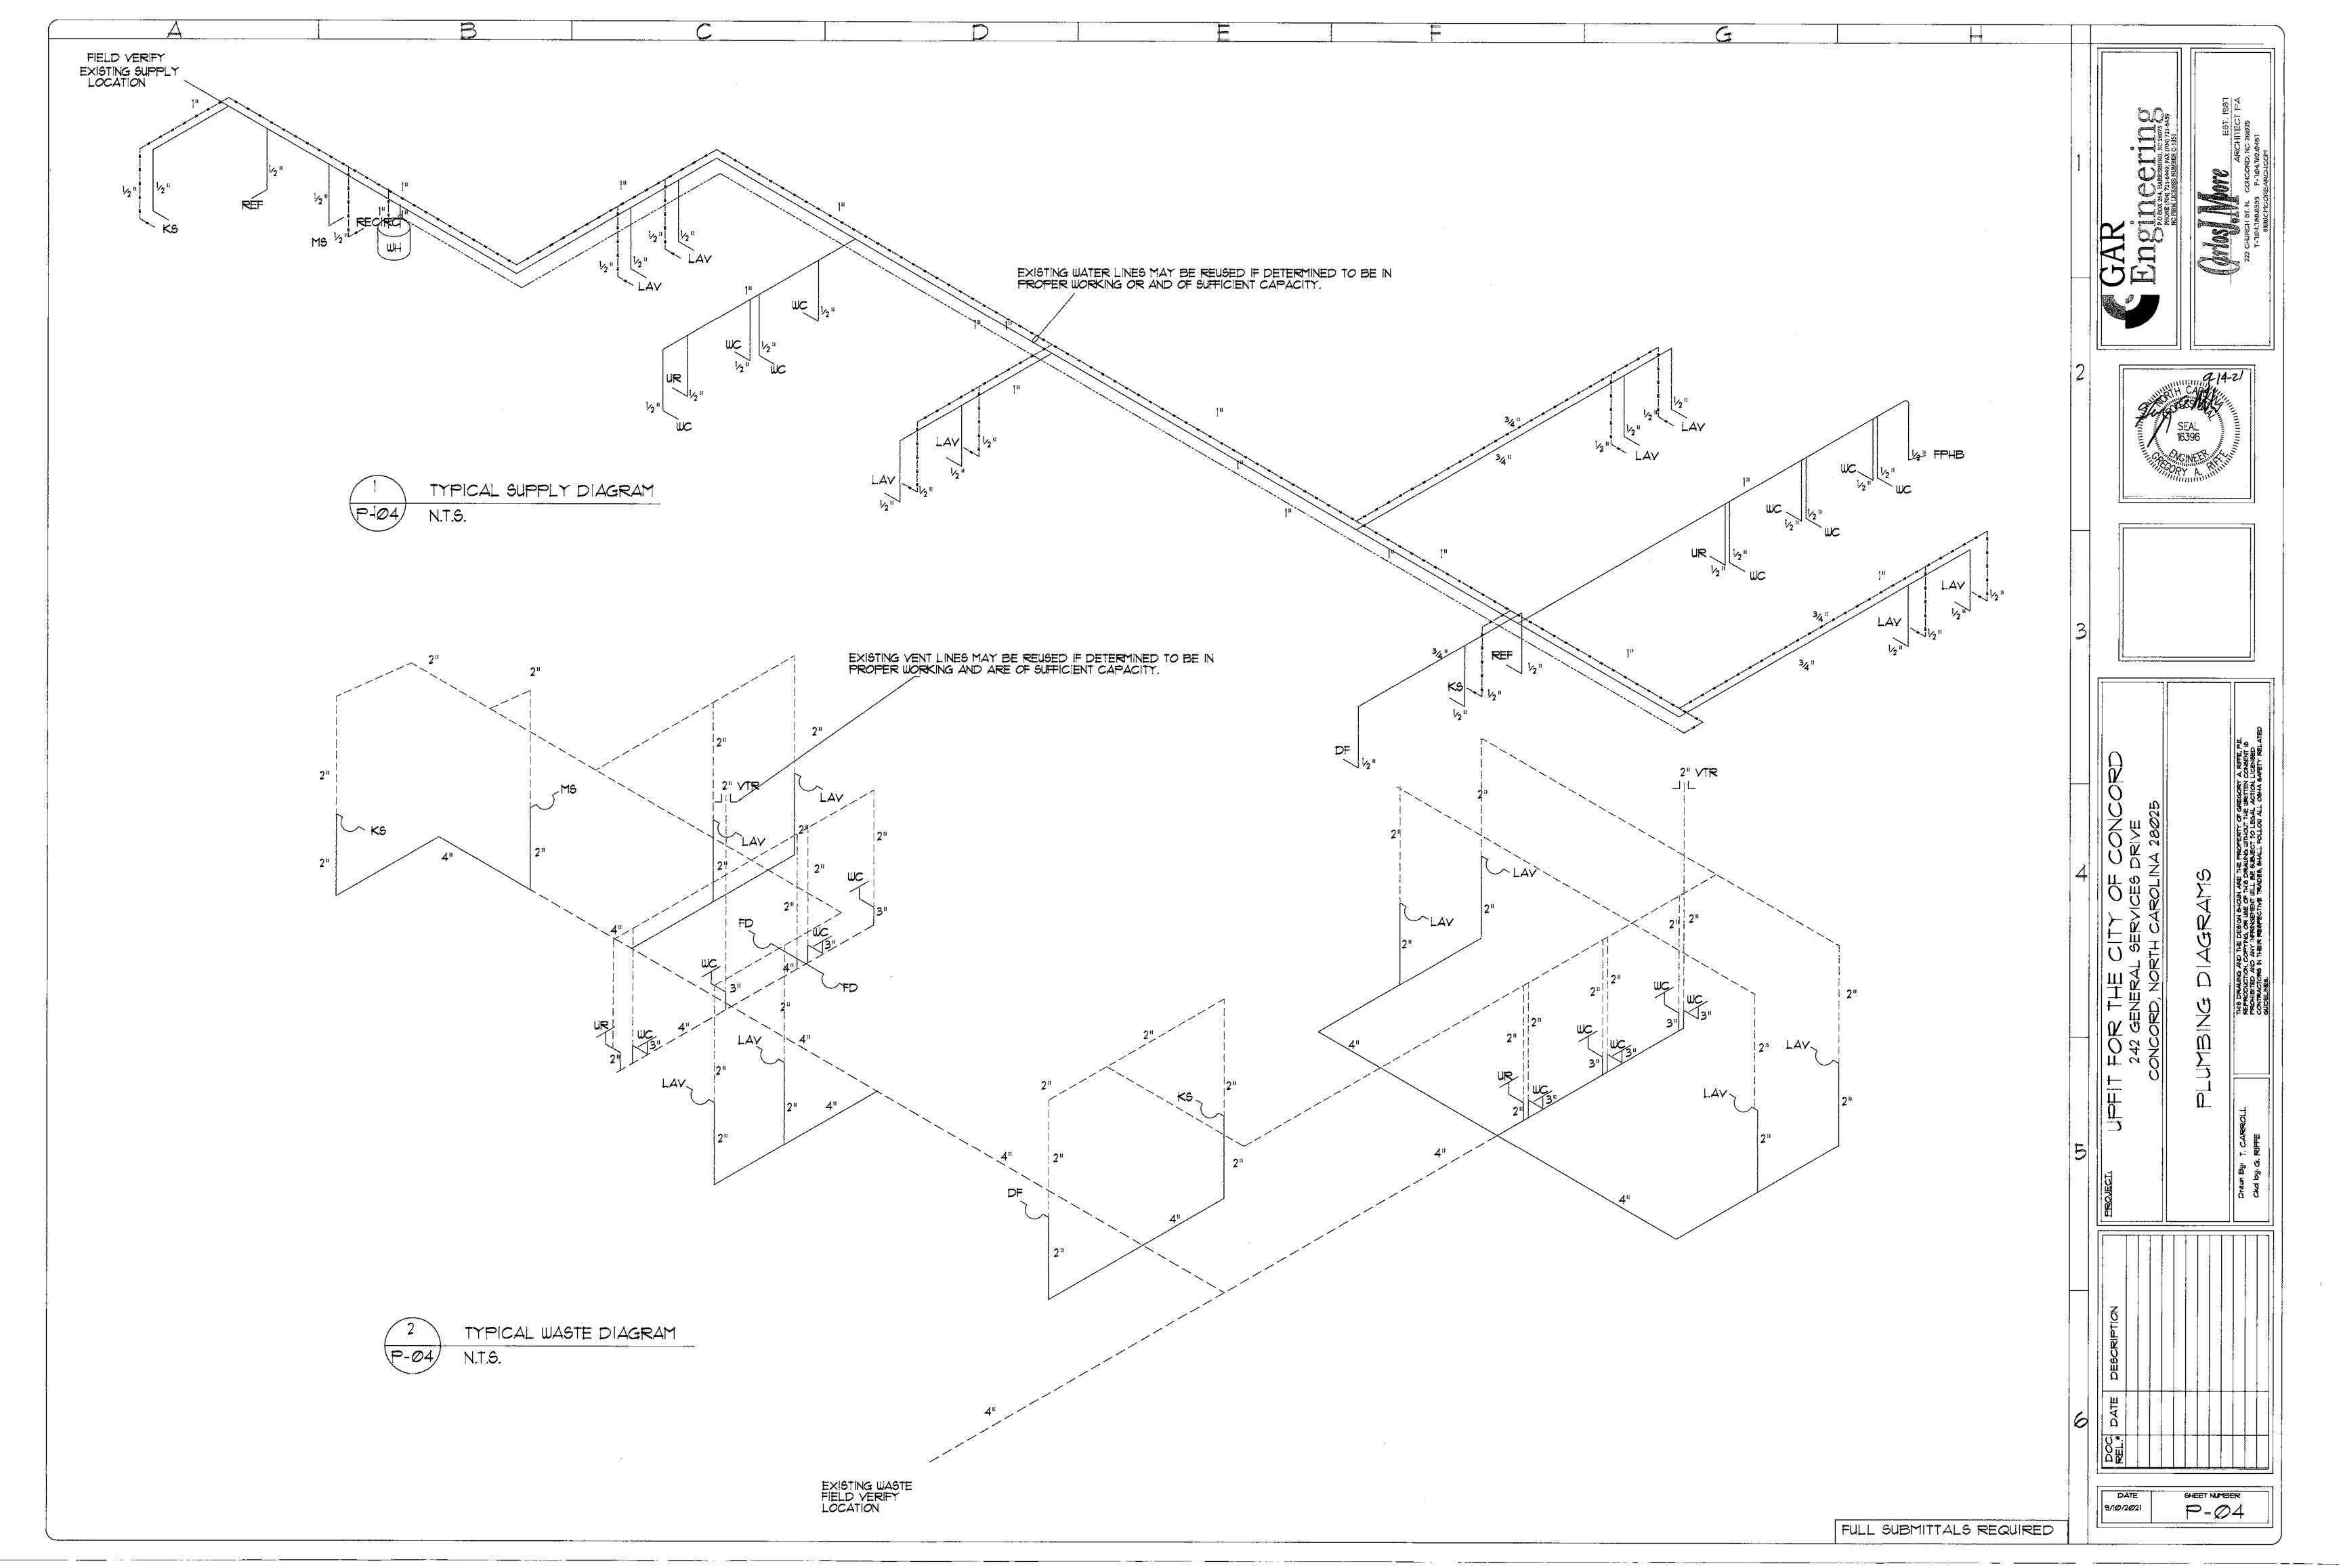

MATERIAL SPECIFICATION P-05


MATERIAL SPECIFICATION:

1) PIPE INSULATION: DG TURBOLIT FOAM VINYL JACKETED WHERE EXPOSED 2) WASTE: SCHEDULE 40 PVC 3) VENT: SCHEDULE 40 PVC / CAST WHERE EXPOSED 4) DOMESTIC WATER: PEX

PLUMBING FIXTURE & EQUIPMENT SCHEDULE

P-05 N.T.S.

SYM.	DESCRIPTION	CONNECTIONS (IN.)				BASIS OF DESIGN	REMARKS	COUNT	WSFU/PER	DFU/PER	TOTAL WSFU	TOTAL DEU
		W	Y	C	HW	SPECIFICATION	RELIANS	COUNT	woru/FER	Dru/FER	IOIAL WORU	IOTAL Dru
WC	WATER CLOSET, TANK TYPE, ADA	3"	2"	4 5 5		MANSFIELD 138-3173 SEAT SB700	OR APPROVED EQUAL	9	5	4	45	36
-AV	LAYATORY, WALL MOUNT WITH FAUCET	2"	2"	1/2"	1/2"	WS COLLECTION UNLIMITED 120 PEERLESS DP188620LFBM	OR APPROVED EQUAL	8	2	1	16	8
(5	KITCHEN SINK WITH FAUCET	2"	2"	1/2"	1/2"	DAYTON DI2522 DELTA 9179-AR-DST	OR APPROVED EQUAL	2	2	1	4	2
JR	URINAL	2"	2"	3/4"		MANSFIELD 401HE SLOAN 186-0.5	OR APPROVED EQUAL	2	5	2	100	4
4 5	MOP SINK	2"	2"	1/2"	1/2"	EXISTING	OR APPROVED EQUAL	1	3	2	3	2
)F	HI-LO DRINKING FOUNTAIN	2"	2"	1/2"		ELKAY ezH20 BOTTLE FILLING BI-LEVEL - EMABFTLDDWSLK	OR APPROVED EQUAL	1	0.5	Ø.25	Ø.5	Ø25
REF	REFRIGERATOR WITH ICE MAKER	7 = =		1/2"		OATEY F2159	OR APPROVED EQUAL		# # # # # # # # # # # # # # # # # # #	**************************************		
 	TANK ELECTRIC WATER HEATER			1 11	\$11	RHEEM E50 50 GAL. 6KW WITH RECIRC TACO 001-F5	OR APPROVED EQUAL		1			
D	FLOOR DRAIN	3"	2"		ļiI	MIFAB FI000 TRAP PRIMED	OR APPROVED EQUAL			•		
PHB	FROST PROOF HOSE BIBB		J.,,	1/2"		WOODFORD MODEL 19	OR APPROVED EQUAL				**************************************	
APPROVED EQUALS			AD.A. COMPLIANCE NOTE		TOTAL		78.5 WSFU	52.25 DFU				
THE CONTRACTOR IS RESPONSIBLE FOR PROVIDING ANY NON-LISTED TRIM AND COMPONENTS						THE PLUMBING CONTRACTOR IS TO VERIFY THAT ALL PLUMBING FIXTURES ARE INSTALLED IN ACCORDANCE WITH THE NC ACCESSIBILITY CODE AS SHOWN ON ARCHITECTURAL PLANS		TOTAL ESTIMATED DEMAND			38 GPM	

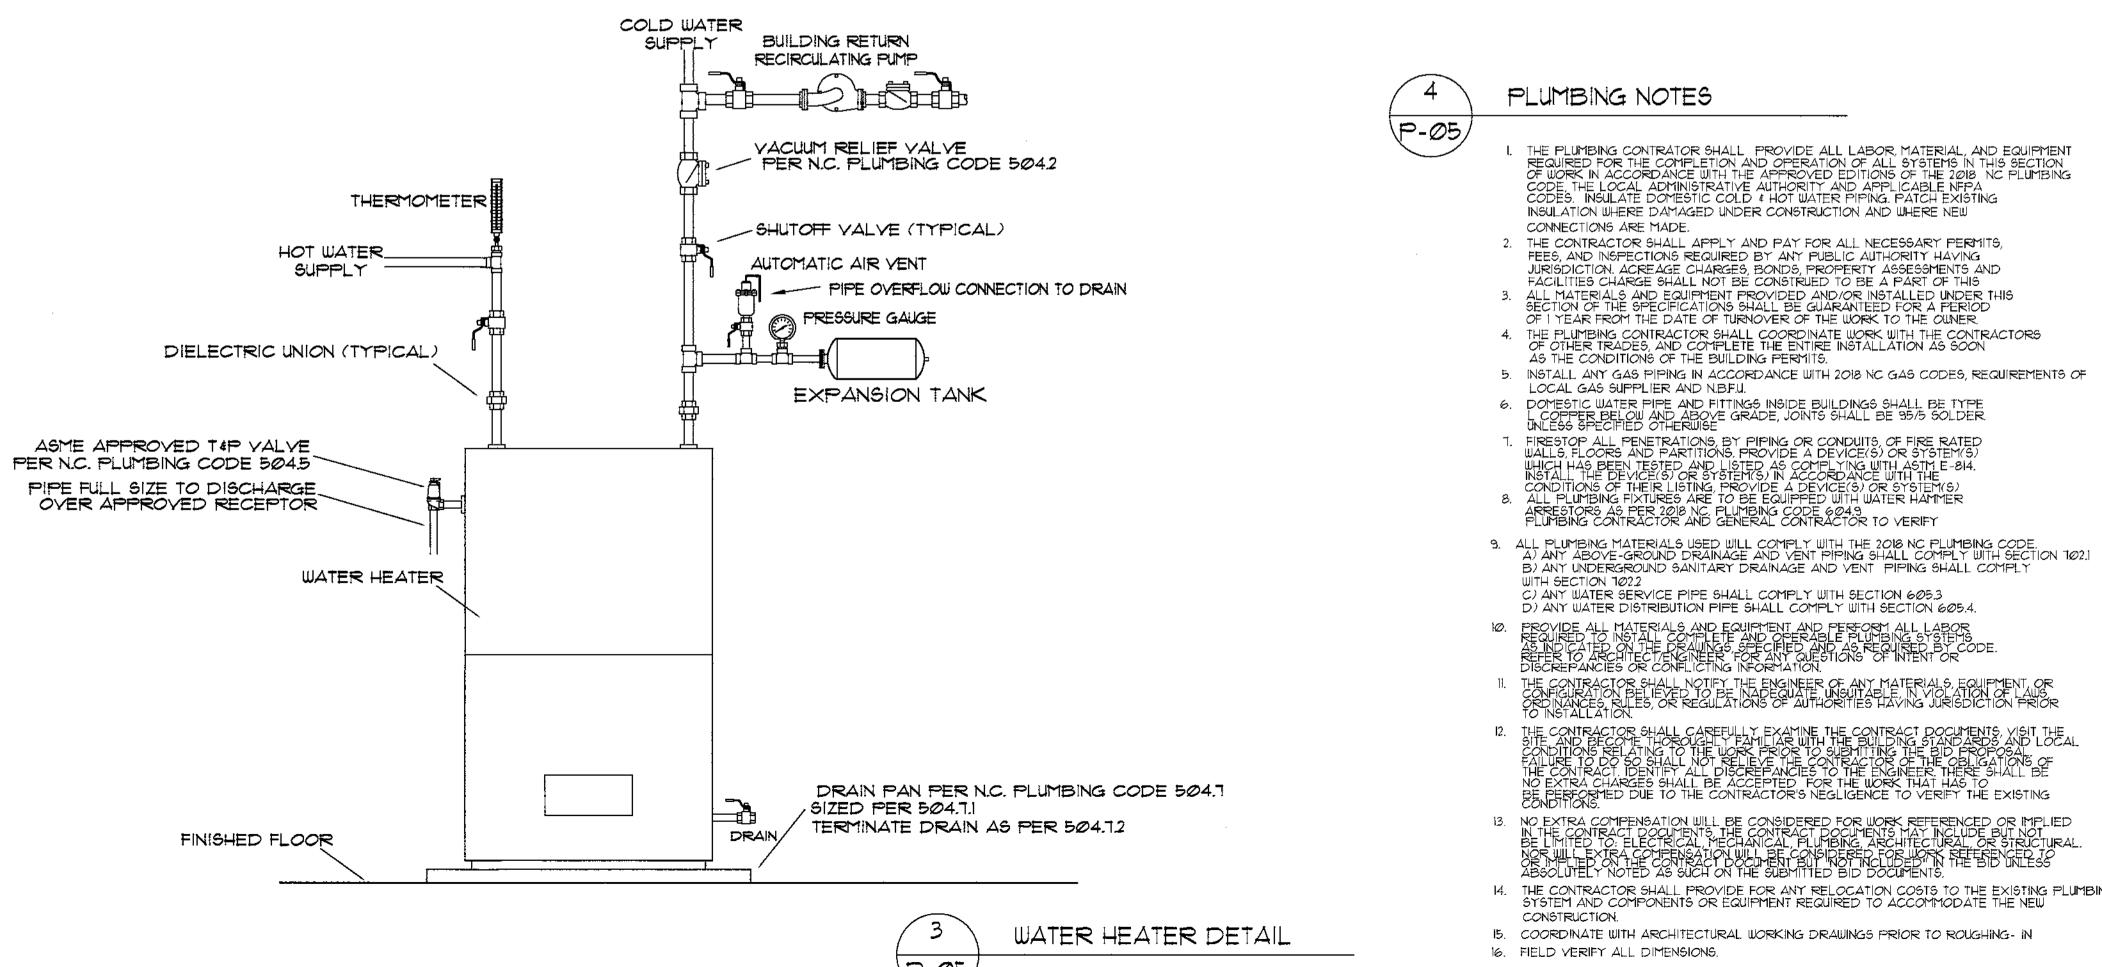

I. THE PLUMBING CONTRATOR SHALL PROVIDE ALL LABOR, MATERIAL, AND EQUIPMENT REQUIRED FOR THE COMPLETION AND OPERATION OF ALL SYSTEMS IN THIS SECTION OF WORK IN ACCORDANCE WITH THE APPROVED EDITIONS OF THE 2018 NC PLUMBING CODE, THE LOCAL ADMINISTRATIVE AUTHORITY AND APPLICABLE NEPA CODES. INSULATE DOMESTIC COLD & HOT WATER PIPING. PATCH EXISTING INSULATION WHERE DAMAGED UNDER CONSTRUCTION AND WHERE NEW THE CONTRACTOR SHALL APPLY AND PAY FOR ALL NECESSARY PERMITS, FEES, AND INSPECTIONS REQUIRED BY ANY PUBLIC AUTHORITY HAVING JURISDICTION. ACREAGE CHARGES, BONDS, PROPERTY ASSESSMENTS AND FACILITIES CHARGE SHALL NOT BE CONSTRUED TO BE A PART OF THIS 3. ALL MATERIALS AND EQUIPMENT PROVIDED AND/OR INSTALLED UNDER THIS SECTION OF THE SPECIFICATIONS SHALL BE GUARANTEED FOR A PERIOD OF 1 YEAR FROM THE DATE OF TURNOVER OF THE WORK TO THE OUNER. 4. THE PLUMBING CONTRACTOR SHALL COORDINATE WORK WITH THE CONTRACTORS OF OTHER TRADES, AND COMPLETE THE ENTIRE INSTALLATION AS SOON AS THE CONDITIONS OF THE BUILDING PERMITS. 5. INSTALL, ANY GAS PIPING IN ACCORDANCE WITH 2018 NO GAS CODES, REQUIREMENTS OF 6. DOMESTIC WATER PIPE AND FITTINGS INSIDE BUILDINGS SHALL BE TYPE L COPPER BELOW AND ABOVE GRADE, JOINTS SHALL BE 95/5 SOLDER. UNLESS SPECIFIED OTHERWISE T. FIRESTOP ALL PENETRATIONS, BY PIPING OR CONDUITS, OF FIRE RATED WALLS, FLOORS AND PARTITIONS, PROVIDE A DEVICE(S) OR SYSTEM(S) WHICH HAS BEEN TESTED AND LISTED AS COMPLYING WITH ASTM E-814. INSTALL THE DEVICE(S) OR SYSTEM(S) IN ACCORDANCE WITH THE CONDITIONS OF THEIR LISTING, PROVIDE A DEVICE(S) OR SYSTEM(S).


8. ALL PLUMBING FIXTURES ARE TO BE EQUIPPED WITH WATER HAMMER ARRESTORS AS PER 2018 NC. PLUMBING CODE 604.9 PLUMBING CONTRACTOR AND GENERAL CONTRACTOR TO VERIFY


C) ANY WATER SERVICE PIPE SHALL COMPLY WITH SECTION 605.3 D) ANY WATER DISTRIBUTION PIPE SHALL COMPLY WITH SECTION 605.4.

THE CONTRACTOR SHALL CAREFULLY EXAMINE THE CONTRACT DOCUMENTS, VISIT THE SITE AND BECOME THOROUGHLY FAMILIAR WITH THE BUILDING STANDARDS AND LOCAL CONDITIONS RELATING TO THE WORK PRIOR TO SUBMITTING THE BID PROPOSAL. FAILURE TO DO SHALL NOT RELIEVE THE CONTRACTOR OF THE OBLIGATIONS OF THE CONTRACT. IDENTIFY ALL DISCREPANCIES TO THE ENGINEER. THERE SHALL BE NO EXTRA CHARGES SHALL BE ACCEPTED FOR THE WORK THAT HAS TO BE PERFORMED DUE TO THE CONTRACTOR'S NEGLIGENCE TO VERIFY THE EXISTING CONDITIONS.

14. THE CONTRACTOR SHALL PROVIDE FOR ANY RELOCATION COSTS TO THE EXISTING PLUMBING SYSTEM AND COMPONENTS OR EQUIPMENT REQUIRED TO ACCOMMODATE THE NEW 15. COORDINATE WITH ARCHITECTURAL WORKING DRAWINGS PRIOR TO ROUGHING- IN

FULL SUBMITTALS REQUIRED

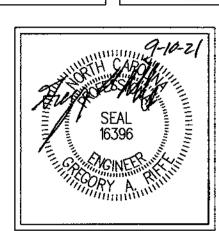


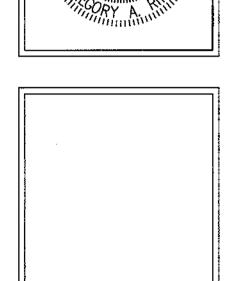



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T FOR THE CITY OF CONCORD 242 GENERAL SERVICES DRIVE CONCORD, NORTH CAROLINA 28025	SING NOTES & DETAILS	THE TRAINING AND THE DESIGN SUCH THE BOOKERDY OF CHECKOY A DESIGN OF
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6

SHEET NUMBER 9/10/2021



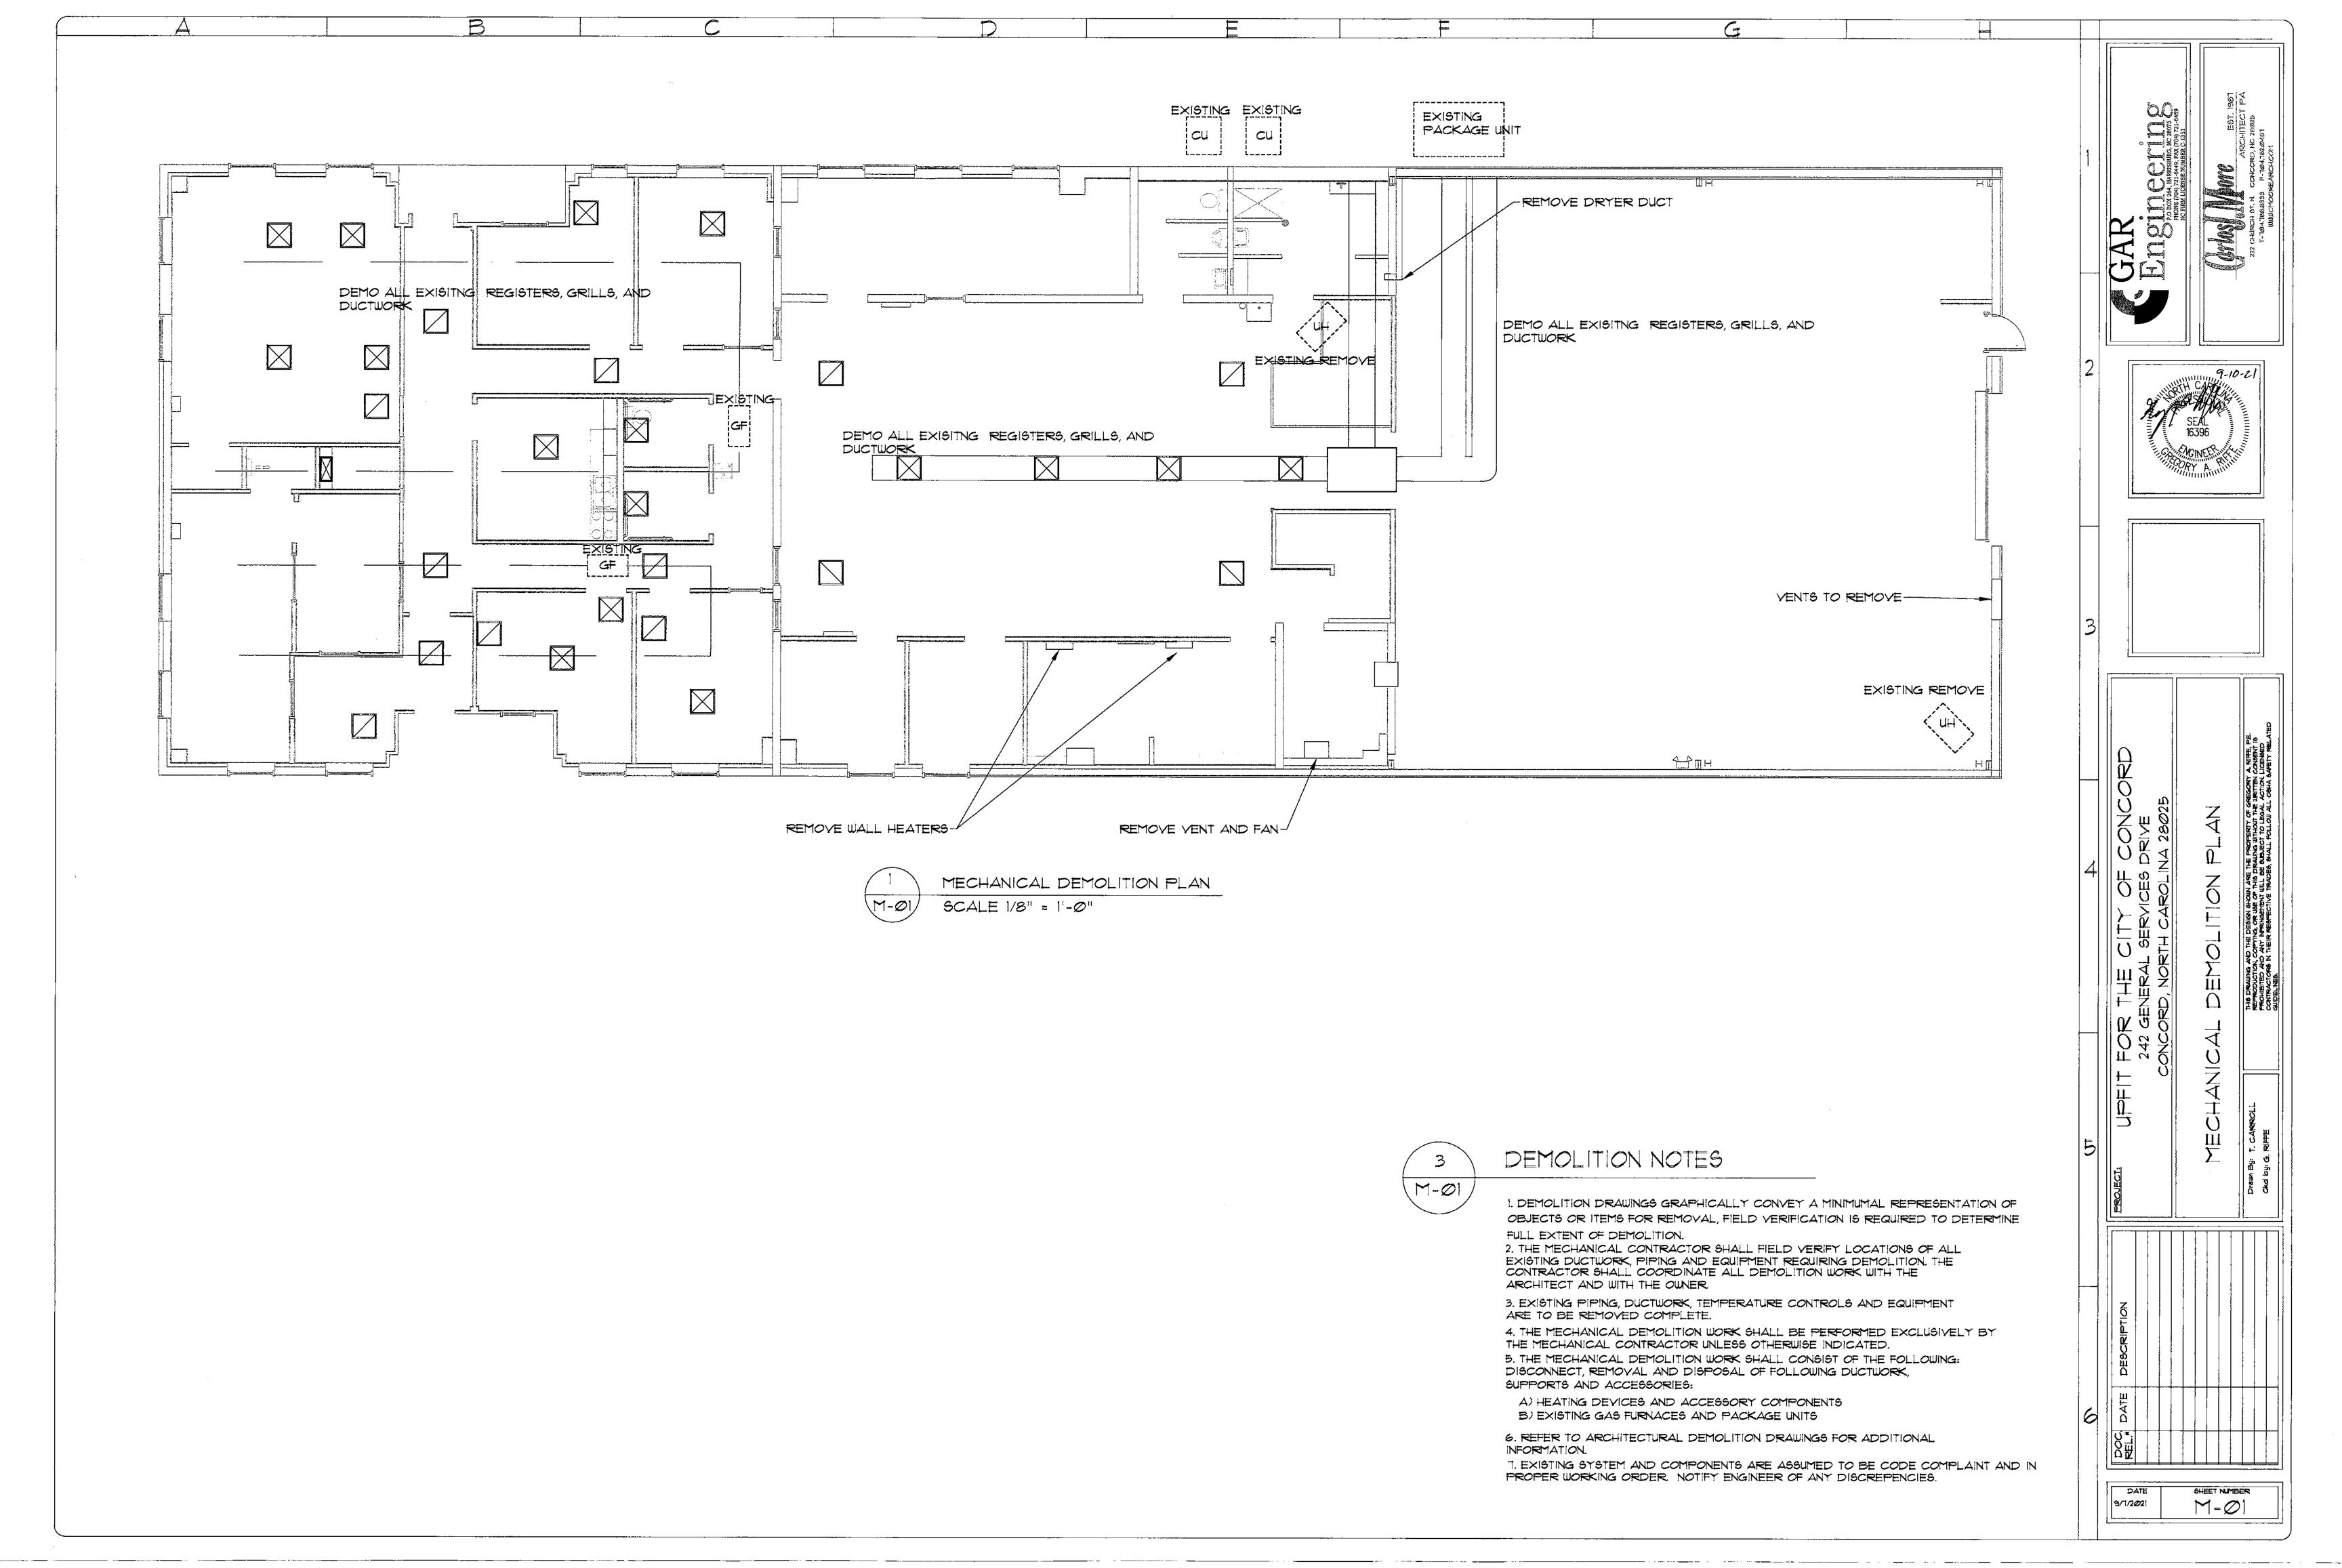

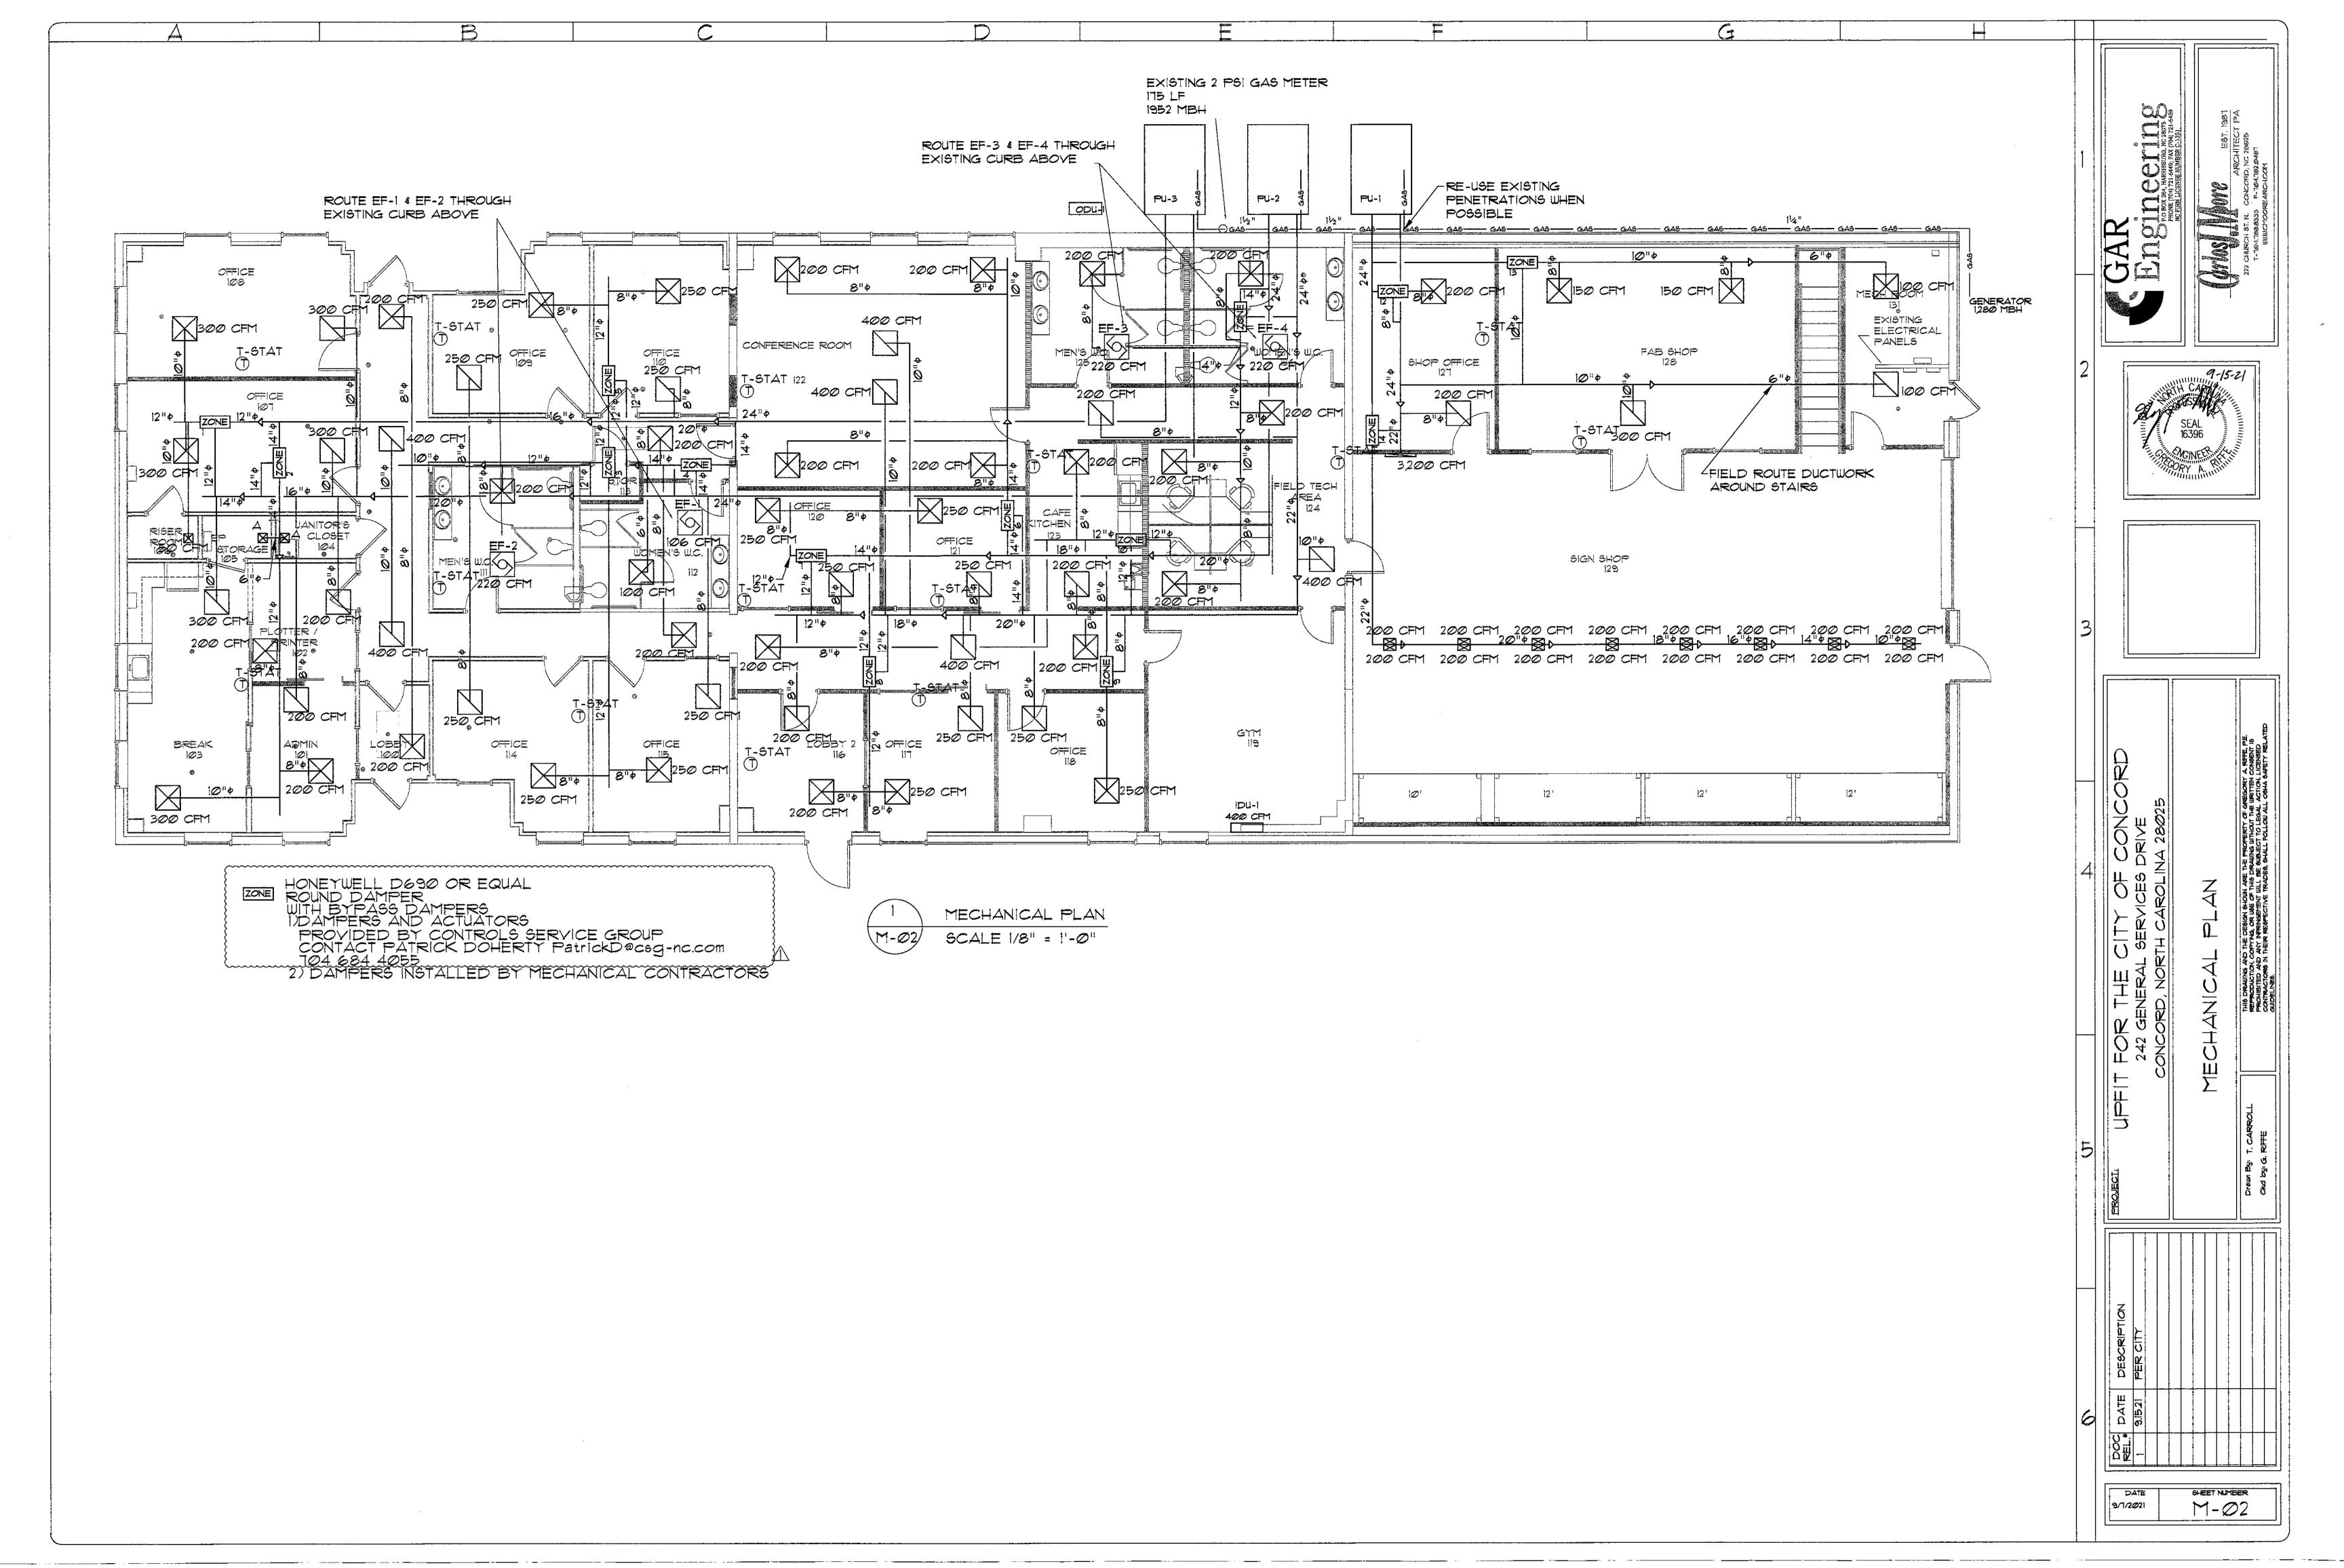

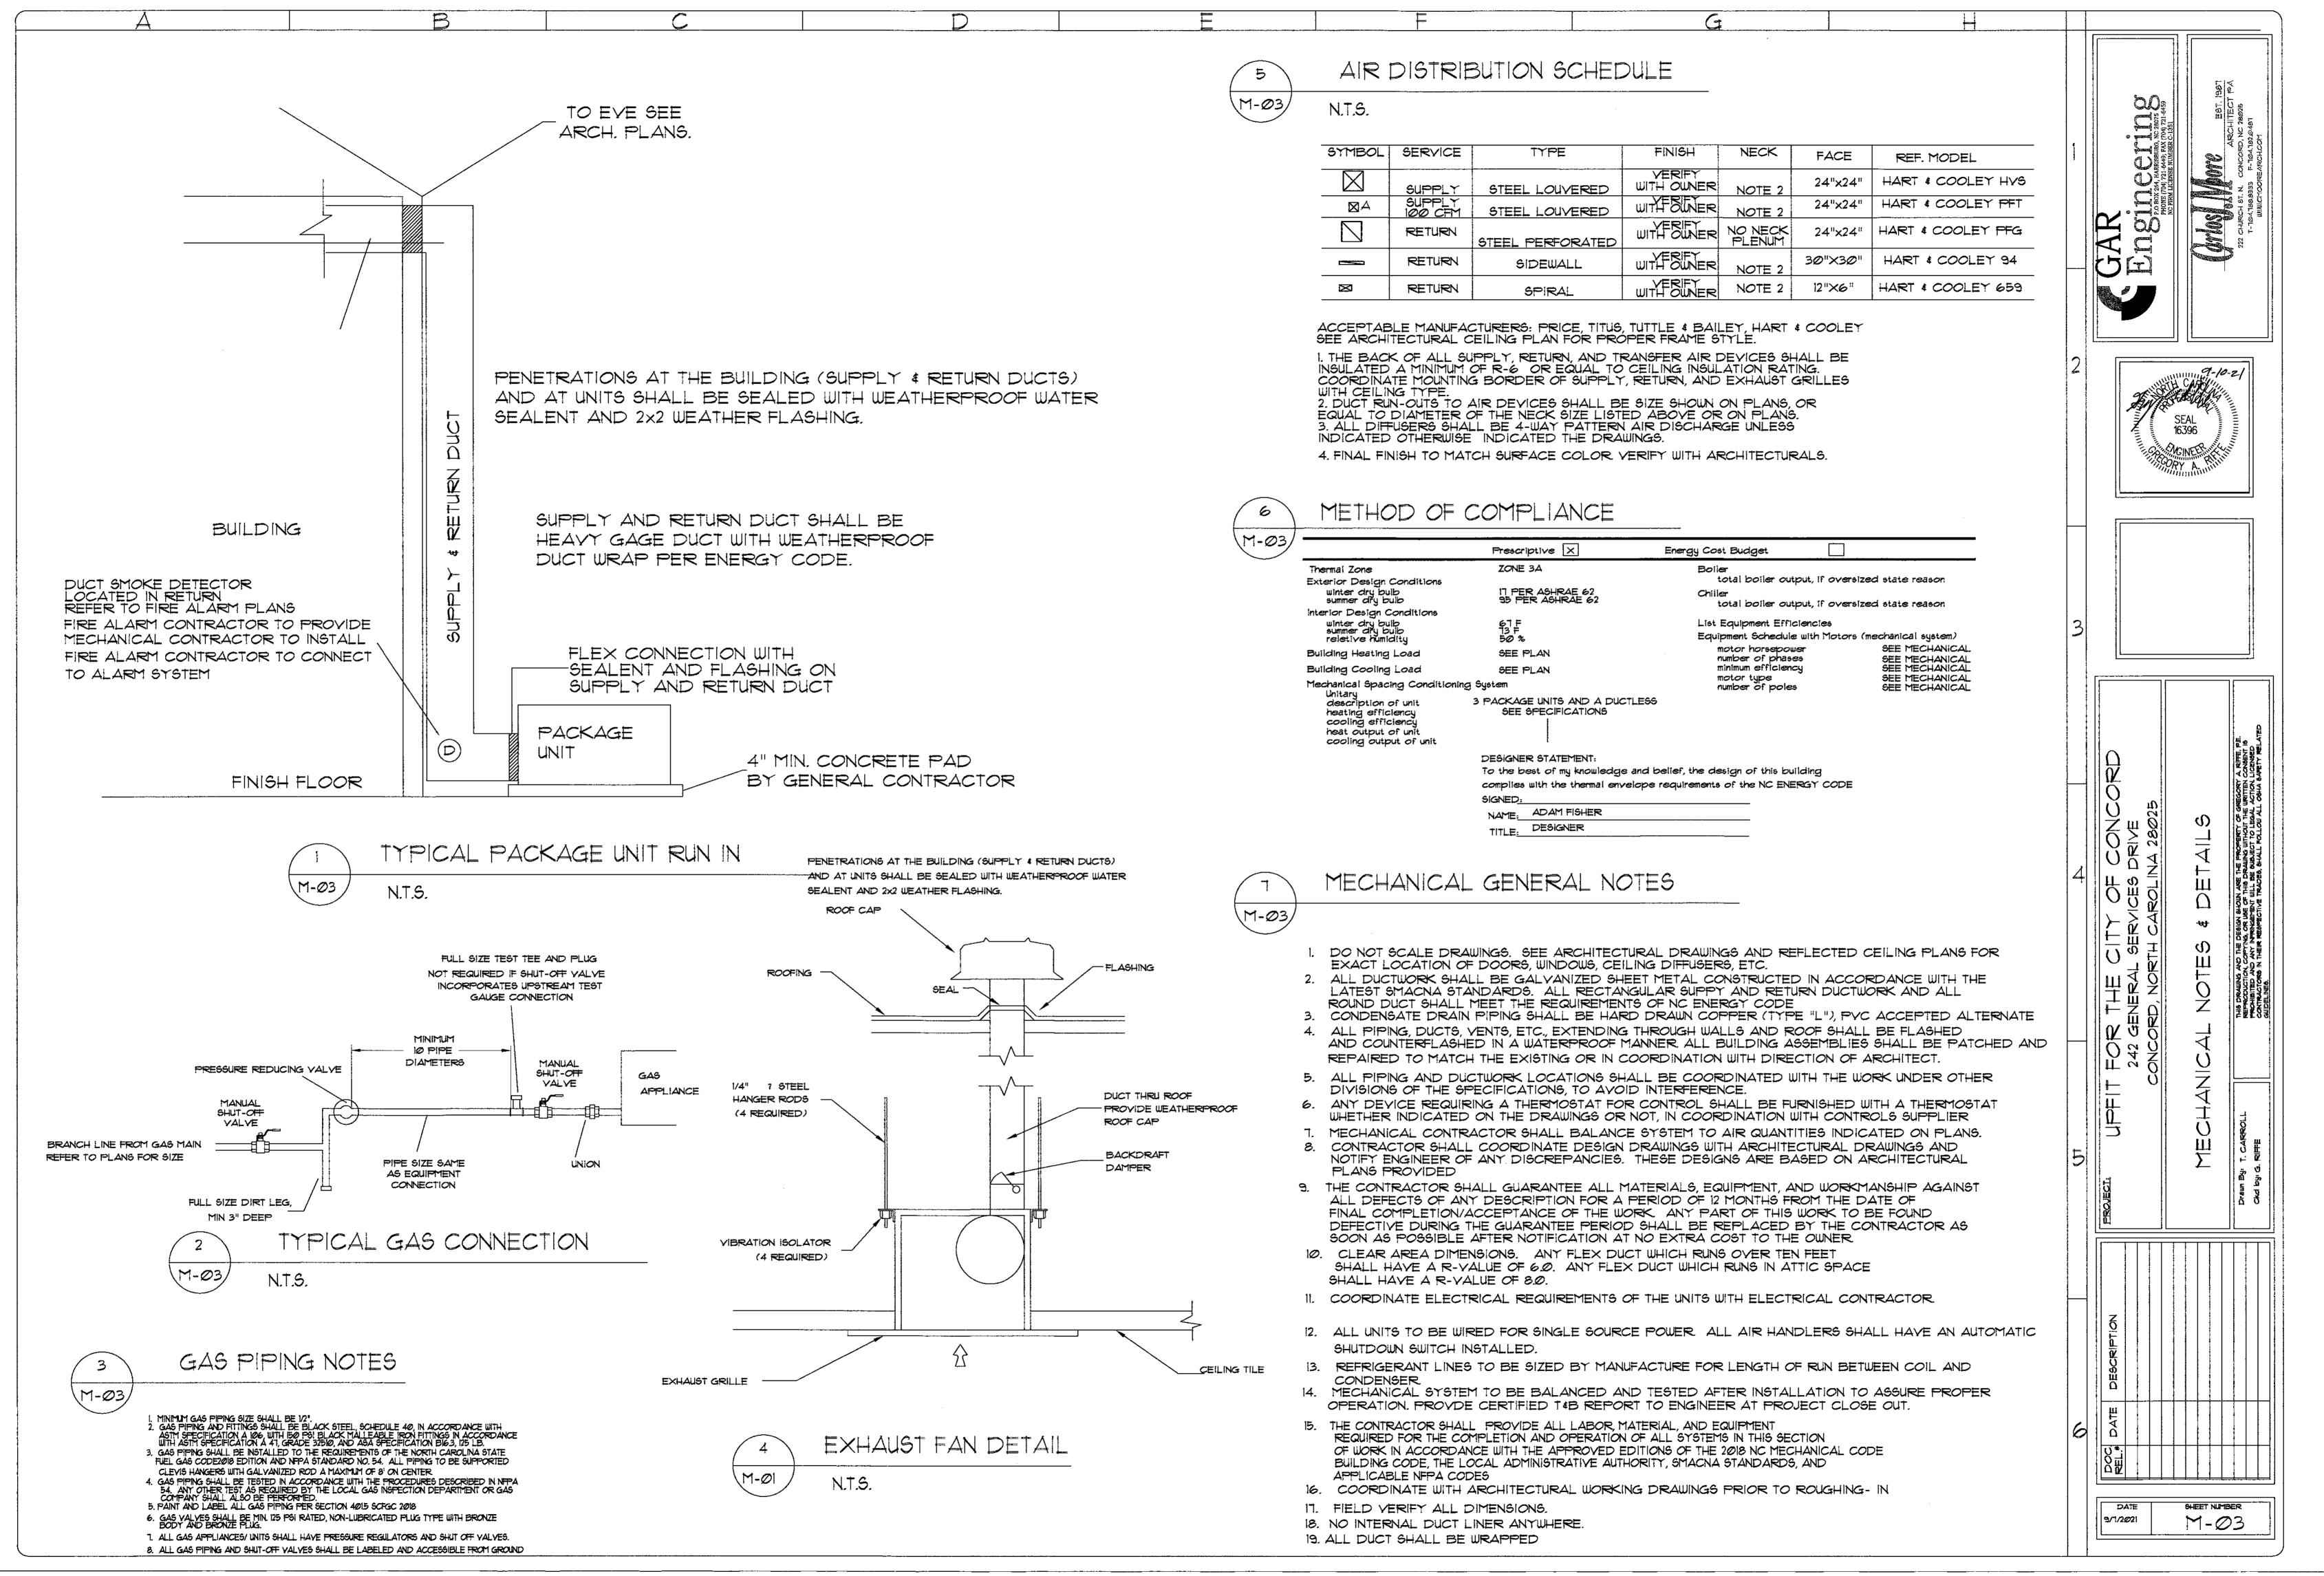BELLMOUTH OF CONICAL TAKEOFF FITTING, FACTORY FABRICATED, SECURE TO DUCT WISELF-ADHESIVE GASKET & SHEET METAL ELECTRICAL SPLIT SYSTEM SCREWS (MIN. OF 4) SUPPORTS PORT OF THE PORT OF THE PORT OF THE PORT OF THE PRINCE OF THE PHONE (1704) 721-649; PAX (1704) 721-649; PA MAX 4'-0" O.C. AND AT ELBOUS M-04 TRUNK DUCT (OR PLENUM) r volume damper, single blade type - ROUND RUNOUT Electrical Split Systems Indoor Unit Outdoor Unit Performance Electrical TRUNK DUCT COMPRESSION FITTING (PROVIDE REDUCER AT THIS POINT WHEN DUCT SIZE IS LARGER DIFFUSER NECK) System EDW SEER Cooling Airflow MCA MOP (F) (F) Tag Tag Capacity Capacity Mode! Number Configuration Model Number Voltage Lif Joint Required USE MALE FITTING U/COMPRESION COUPLING (Btuh) (A)(Btuh) -RIGID ROUND DUCT REQUIRED TO THIS Wall Mounted 12,200 90 73 16 400 3,000 208/1/60 9 15 IDU-1 NTXWEL12A112A ODU-1 NTXSEL12A112A 1. INSTALLED PER MANUFACTURER SPECIFICATIONS 2. EQUIPPED WITH BACNET MODULE TO CONNECT WITH RELIABLE CONTROL SYSTEMS 3. HEAT PUMP INSTALLED ON CONCRETE PAD DIFFUSER (CONFIGURATION 9-15-21 MAY YARY) CEILING (SEE ROOM FINISH SCHEDULE FOR TYPE) PACKAGED UNIT SCHEDULE M-04 ROUND DUCT BRANCH TAKEOFF HEAT. CAP. GAS INPUT VOLTAGE/PHASE MODEL MOP EER MAKE TOTAL CFM WEIGHT COOL. CAP M-04 N.T.S. 224 MBH CARRIER 11.5 48HCED12A2A5-0A0G0 89.56 MBH 184.0 MBH 4,000 PU-1 - 3 1099 LBS 23Ø V-3¢ 52 A 60 A 1. WITH RELIABLE CONTROL SYSTEM, INTEGRATED WITH CITY SYSTEM 2. WITH ECONOMIZER 3. WITH ALL MANUFACTURER GUIDELINE AND RECOMMENDATION COMPONENTS 4. WITH ALL CODE REQUIRED COMPONENTS 5. WITH American Light & Power CK 48" dual light kits CONTACT Ivan at AL&P 1-843-306-0070 EXHAUST FANS & LOUVER M-04/ MOTOR FAN CONTROL MAKE MODEL LOCATION TAG TYPE METHOD YOLTAGE ESP (IN. WG.) AMPS AIRFLOW (CFM) PHASE VENT THROUGH CEILING CAP INTERLOCK WITH CEILING EF-1 **VENTILATOR** 106 .125 58 GREENHECK SP-AIIO 12ØV LIGHTS COORDINATE WITH GENERAL CONTRACTOR **** YENT THROUGH WALL CAP INTERLOCK WITH EF-2 - 4 CEILING **YENTILATOR** GREENHECK SP-A200 220 .125 .43 8" YENT 12ØV LIGHTS COORDINATE WITH GENERAL CONTRACTOR VENTILATION CALCULATIONS

VENTILATION

EFFECTIVENESS

ZONE VENTILATION PROVIDED BY

PU-1

PU-2

PU-3

SHEET NUMBER

M-Ø4

9/1/2021

(VOZ=VBX/EZ)

245

255

506

M-04

SPACE

SPACE A

SPACE B

SPACE C

DEFAULT

OCCUPANCY

(PEOPLE/1000 SF)

10

AREA

(SF)

2,300

2,400

2,380

CLASSIFICATION

OFFICE

OFFICE

SHOP

OUTDOOR

AIR RATE

(CFM/PERSON)

OUTDOOR BREATHING ZONE

VENTILATION

(VBZ)

195.5

204


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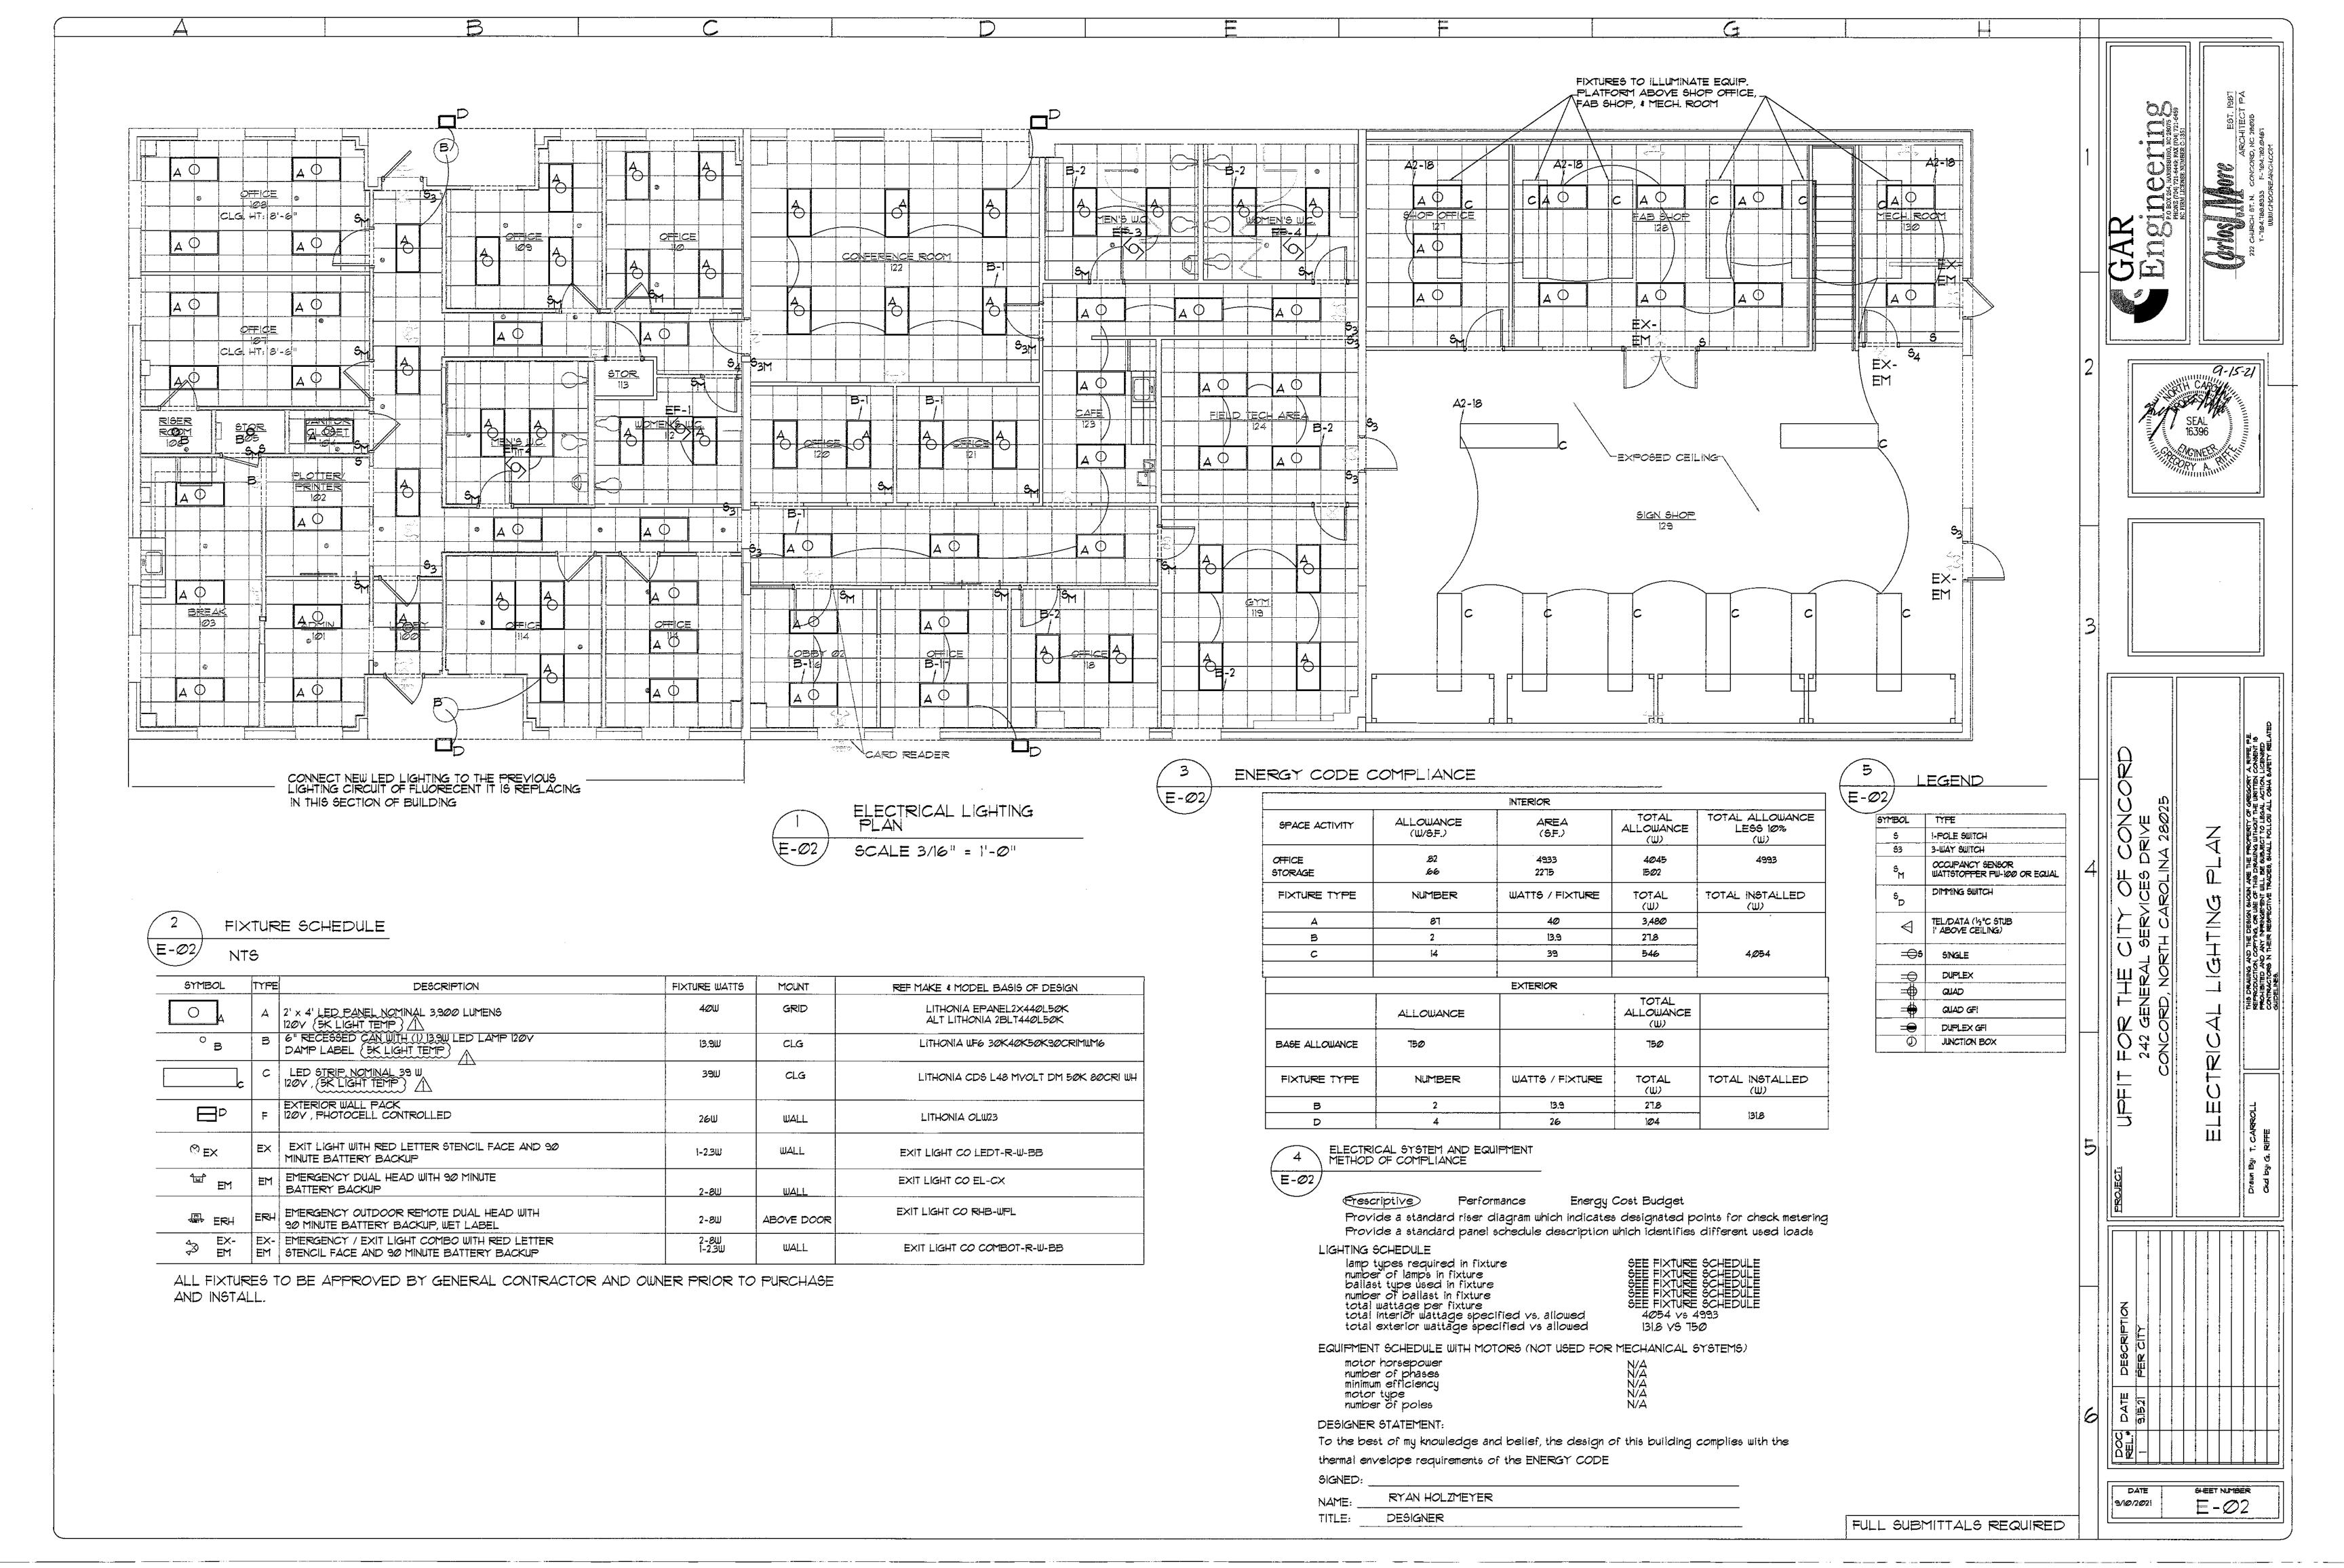
AIR RATE


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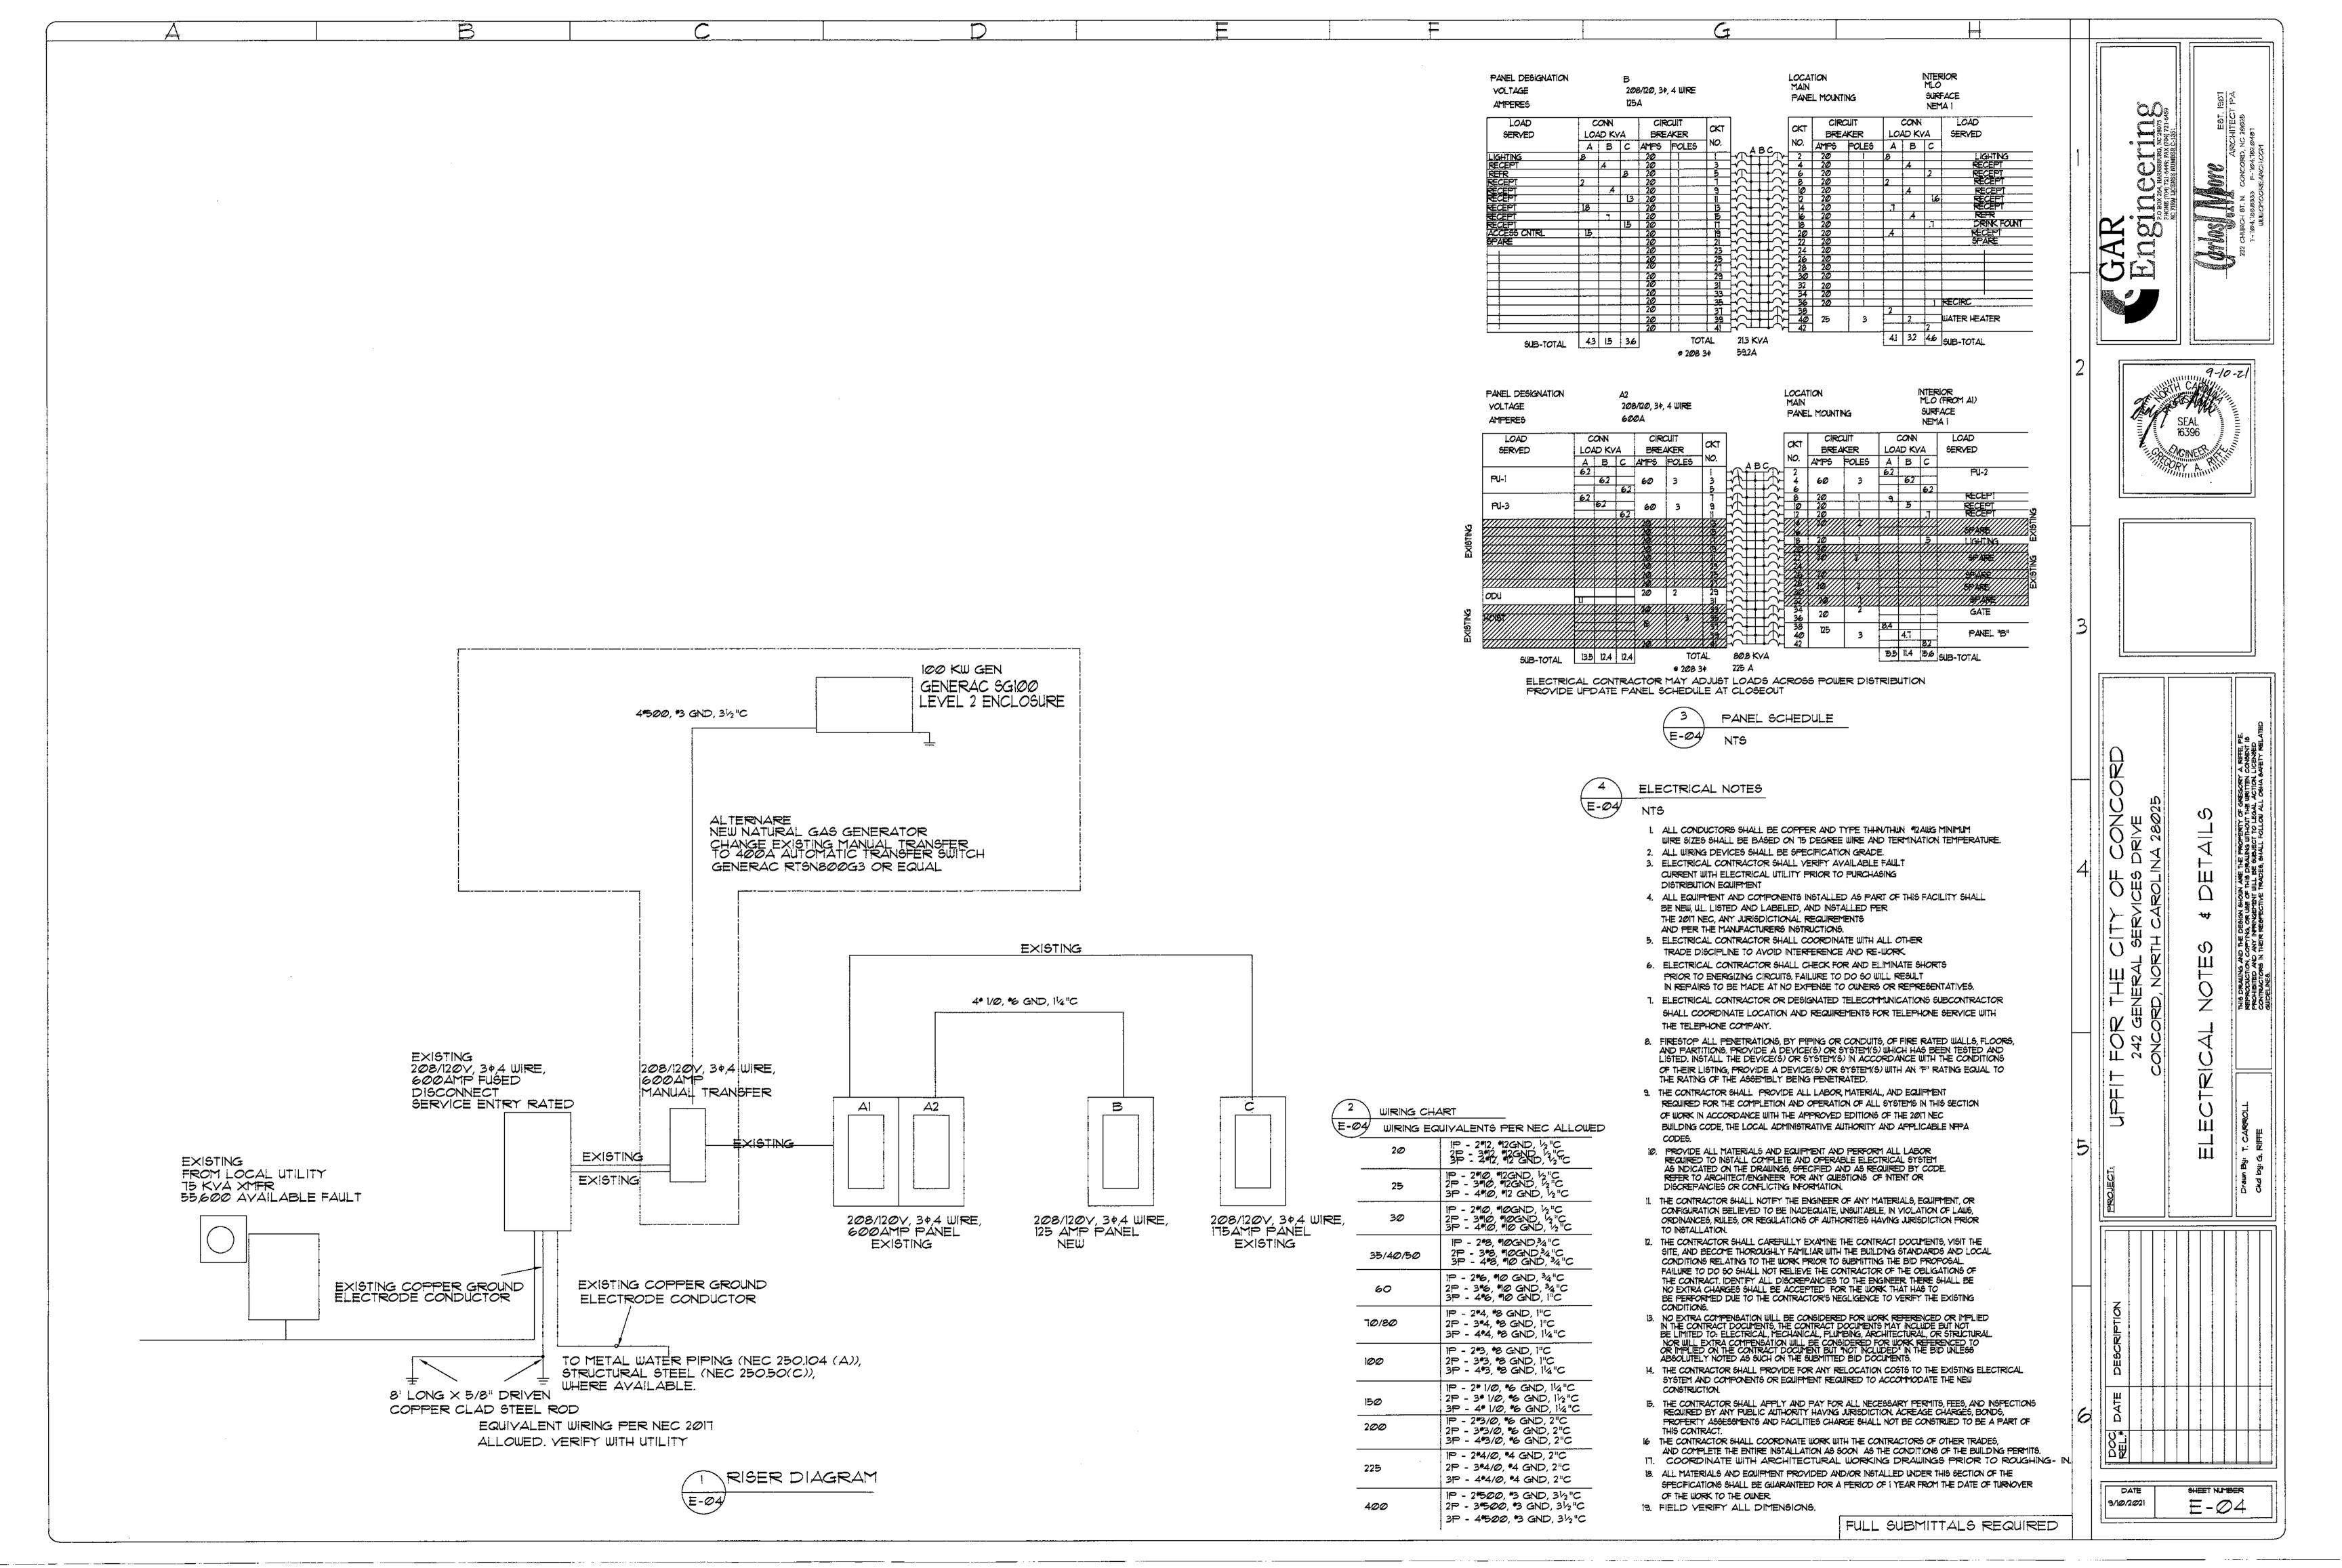
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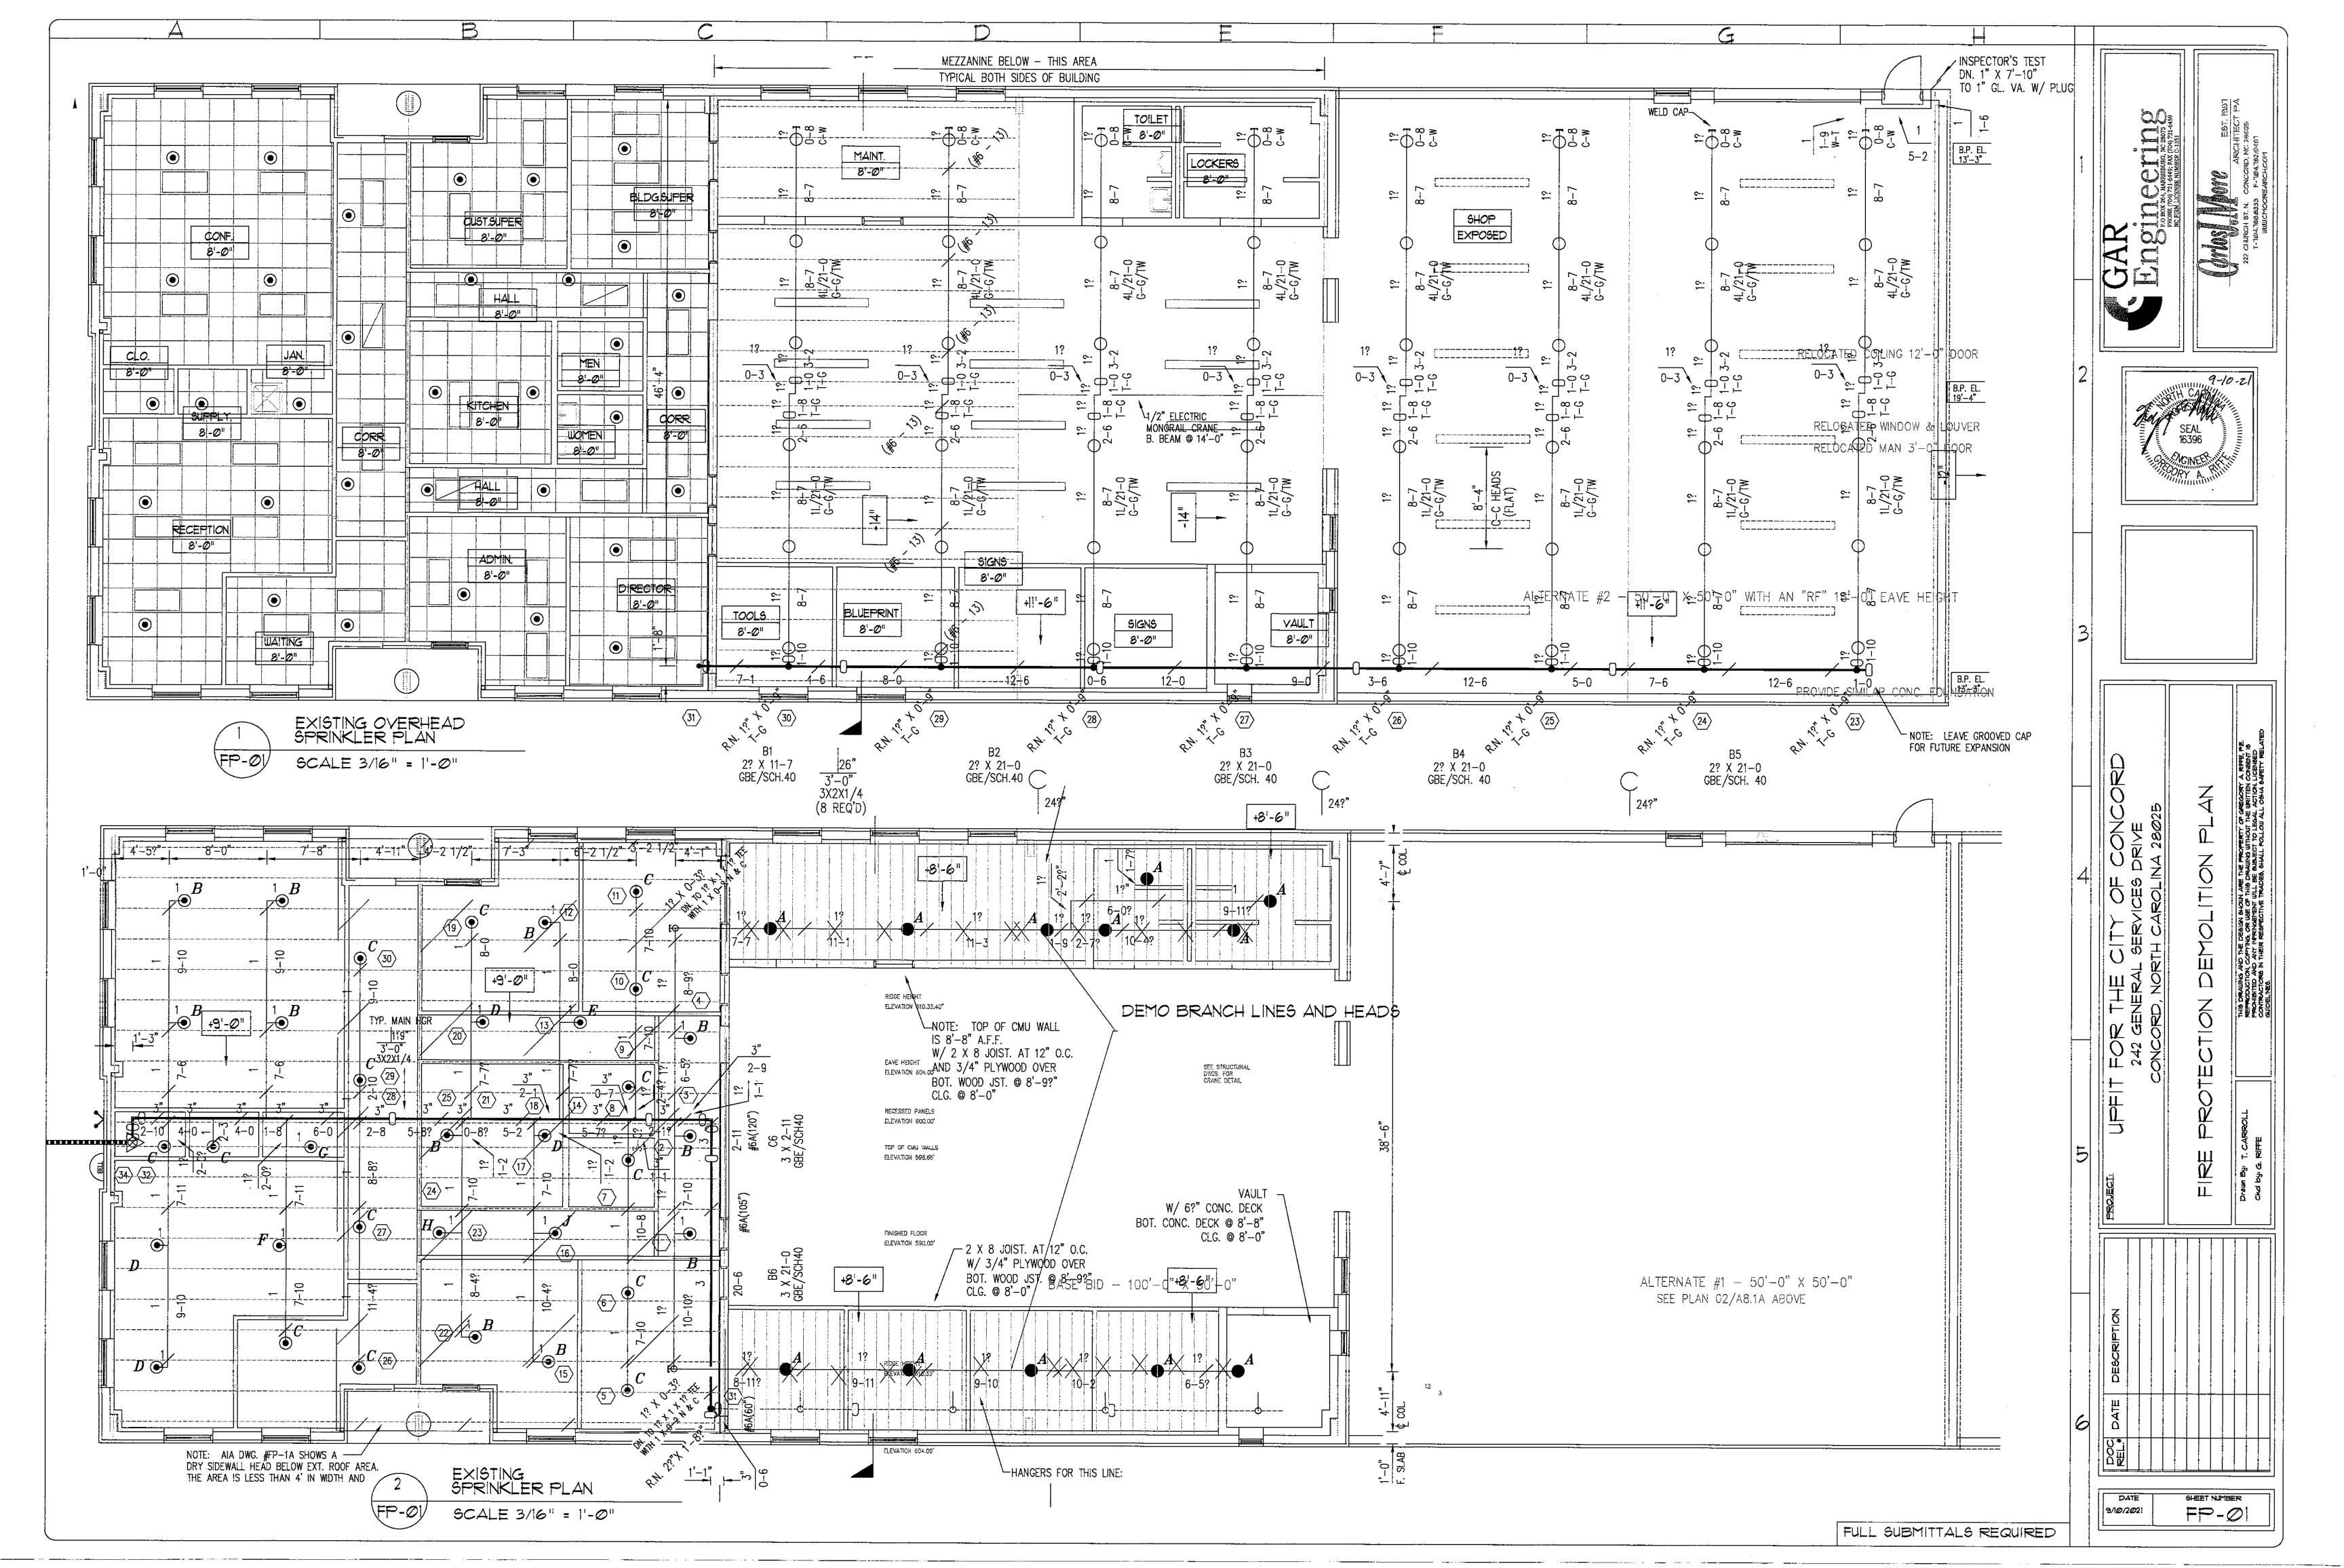
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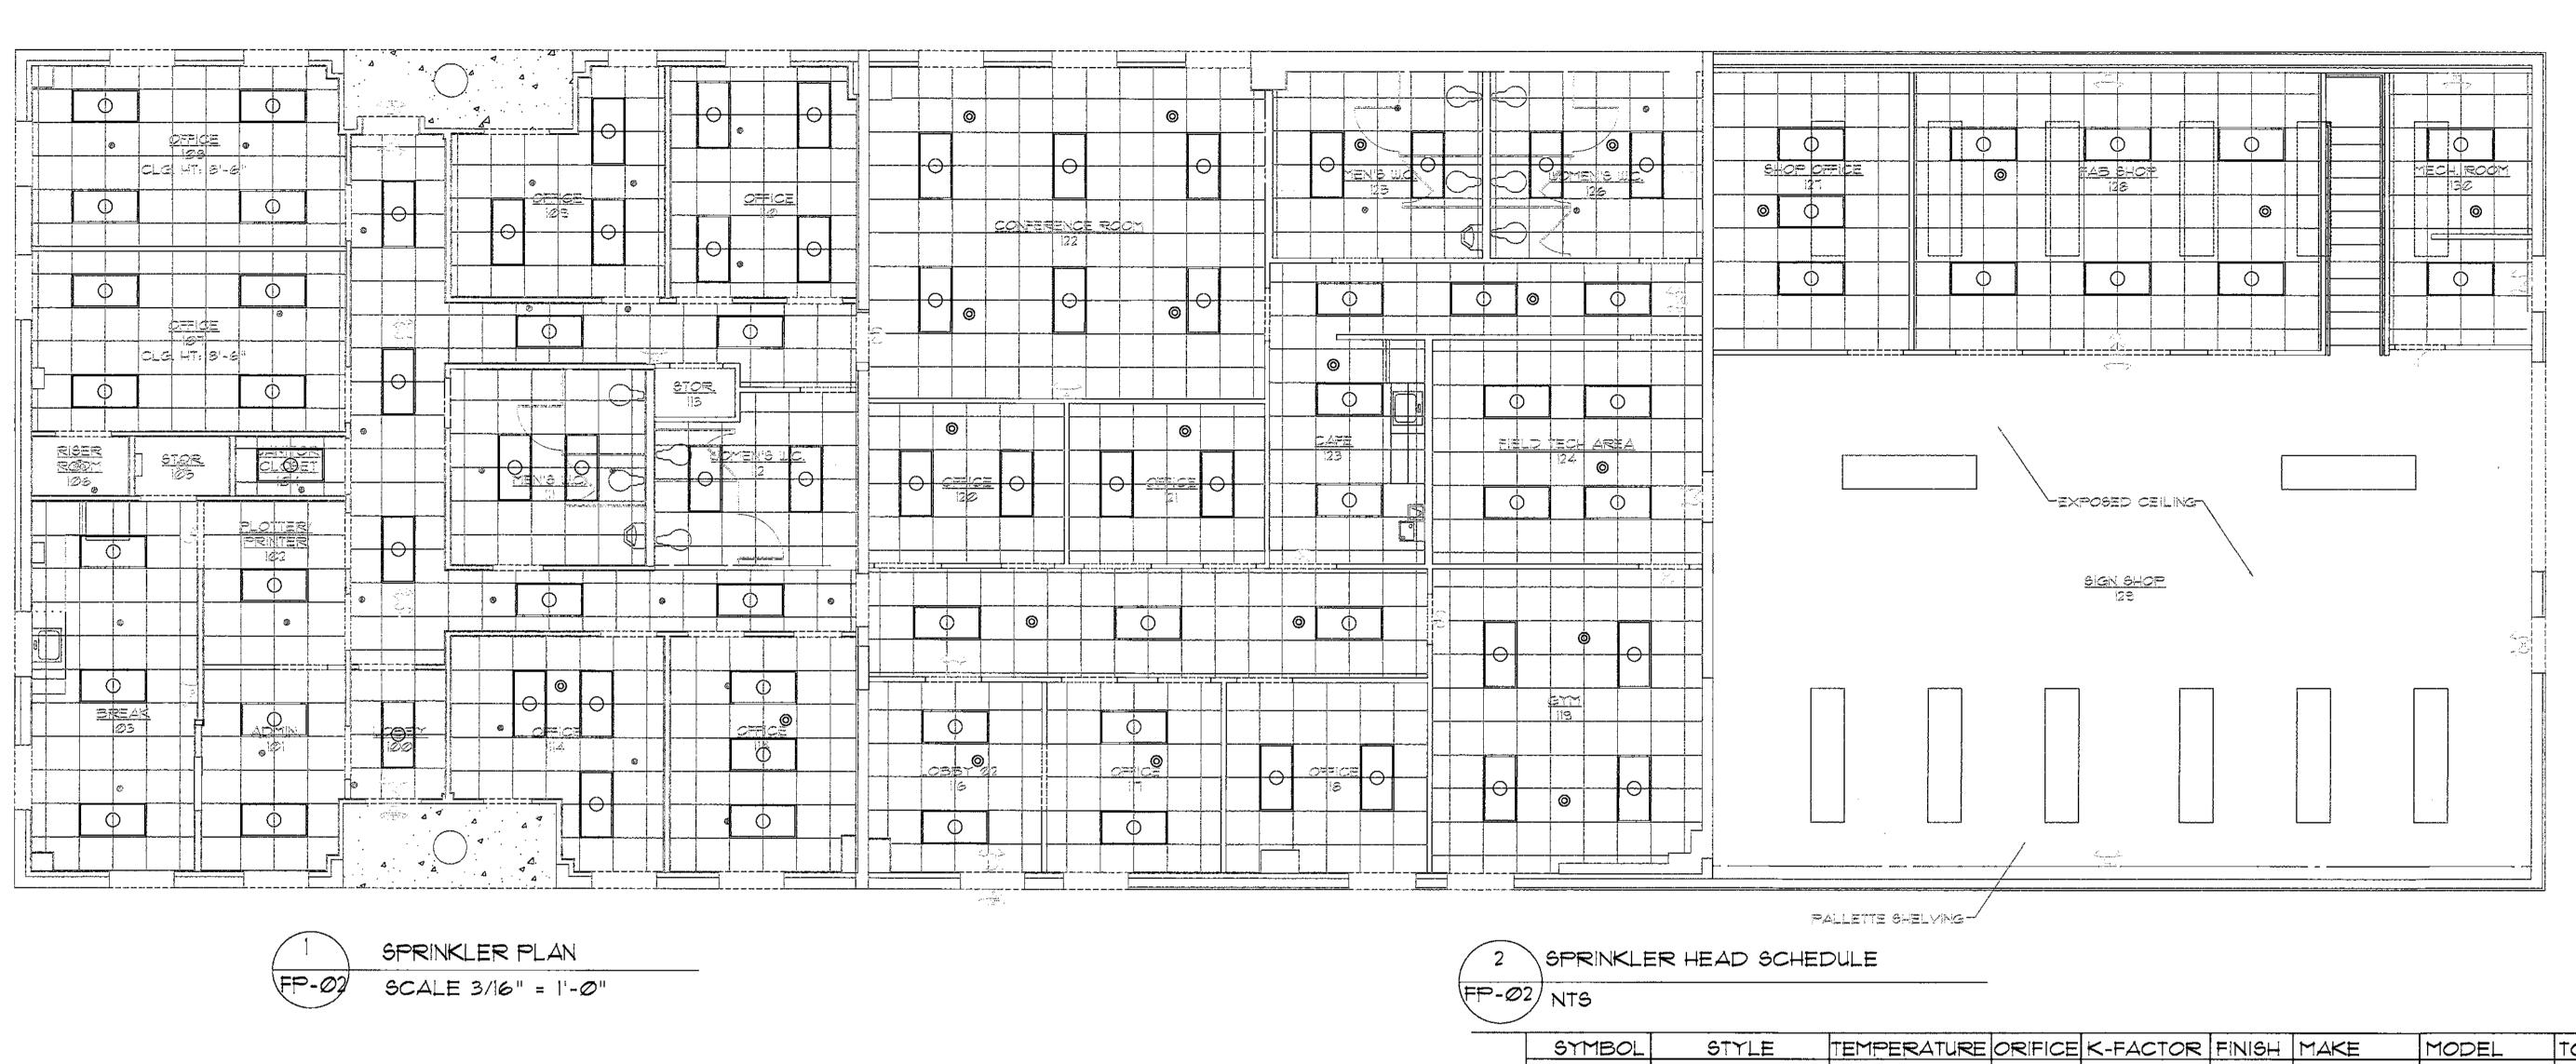









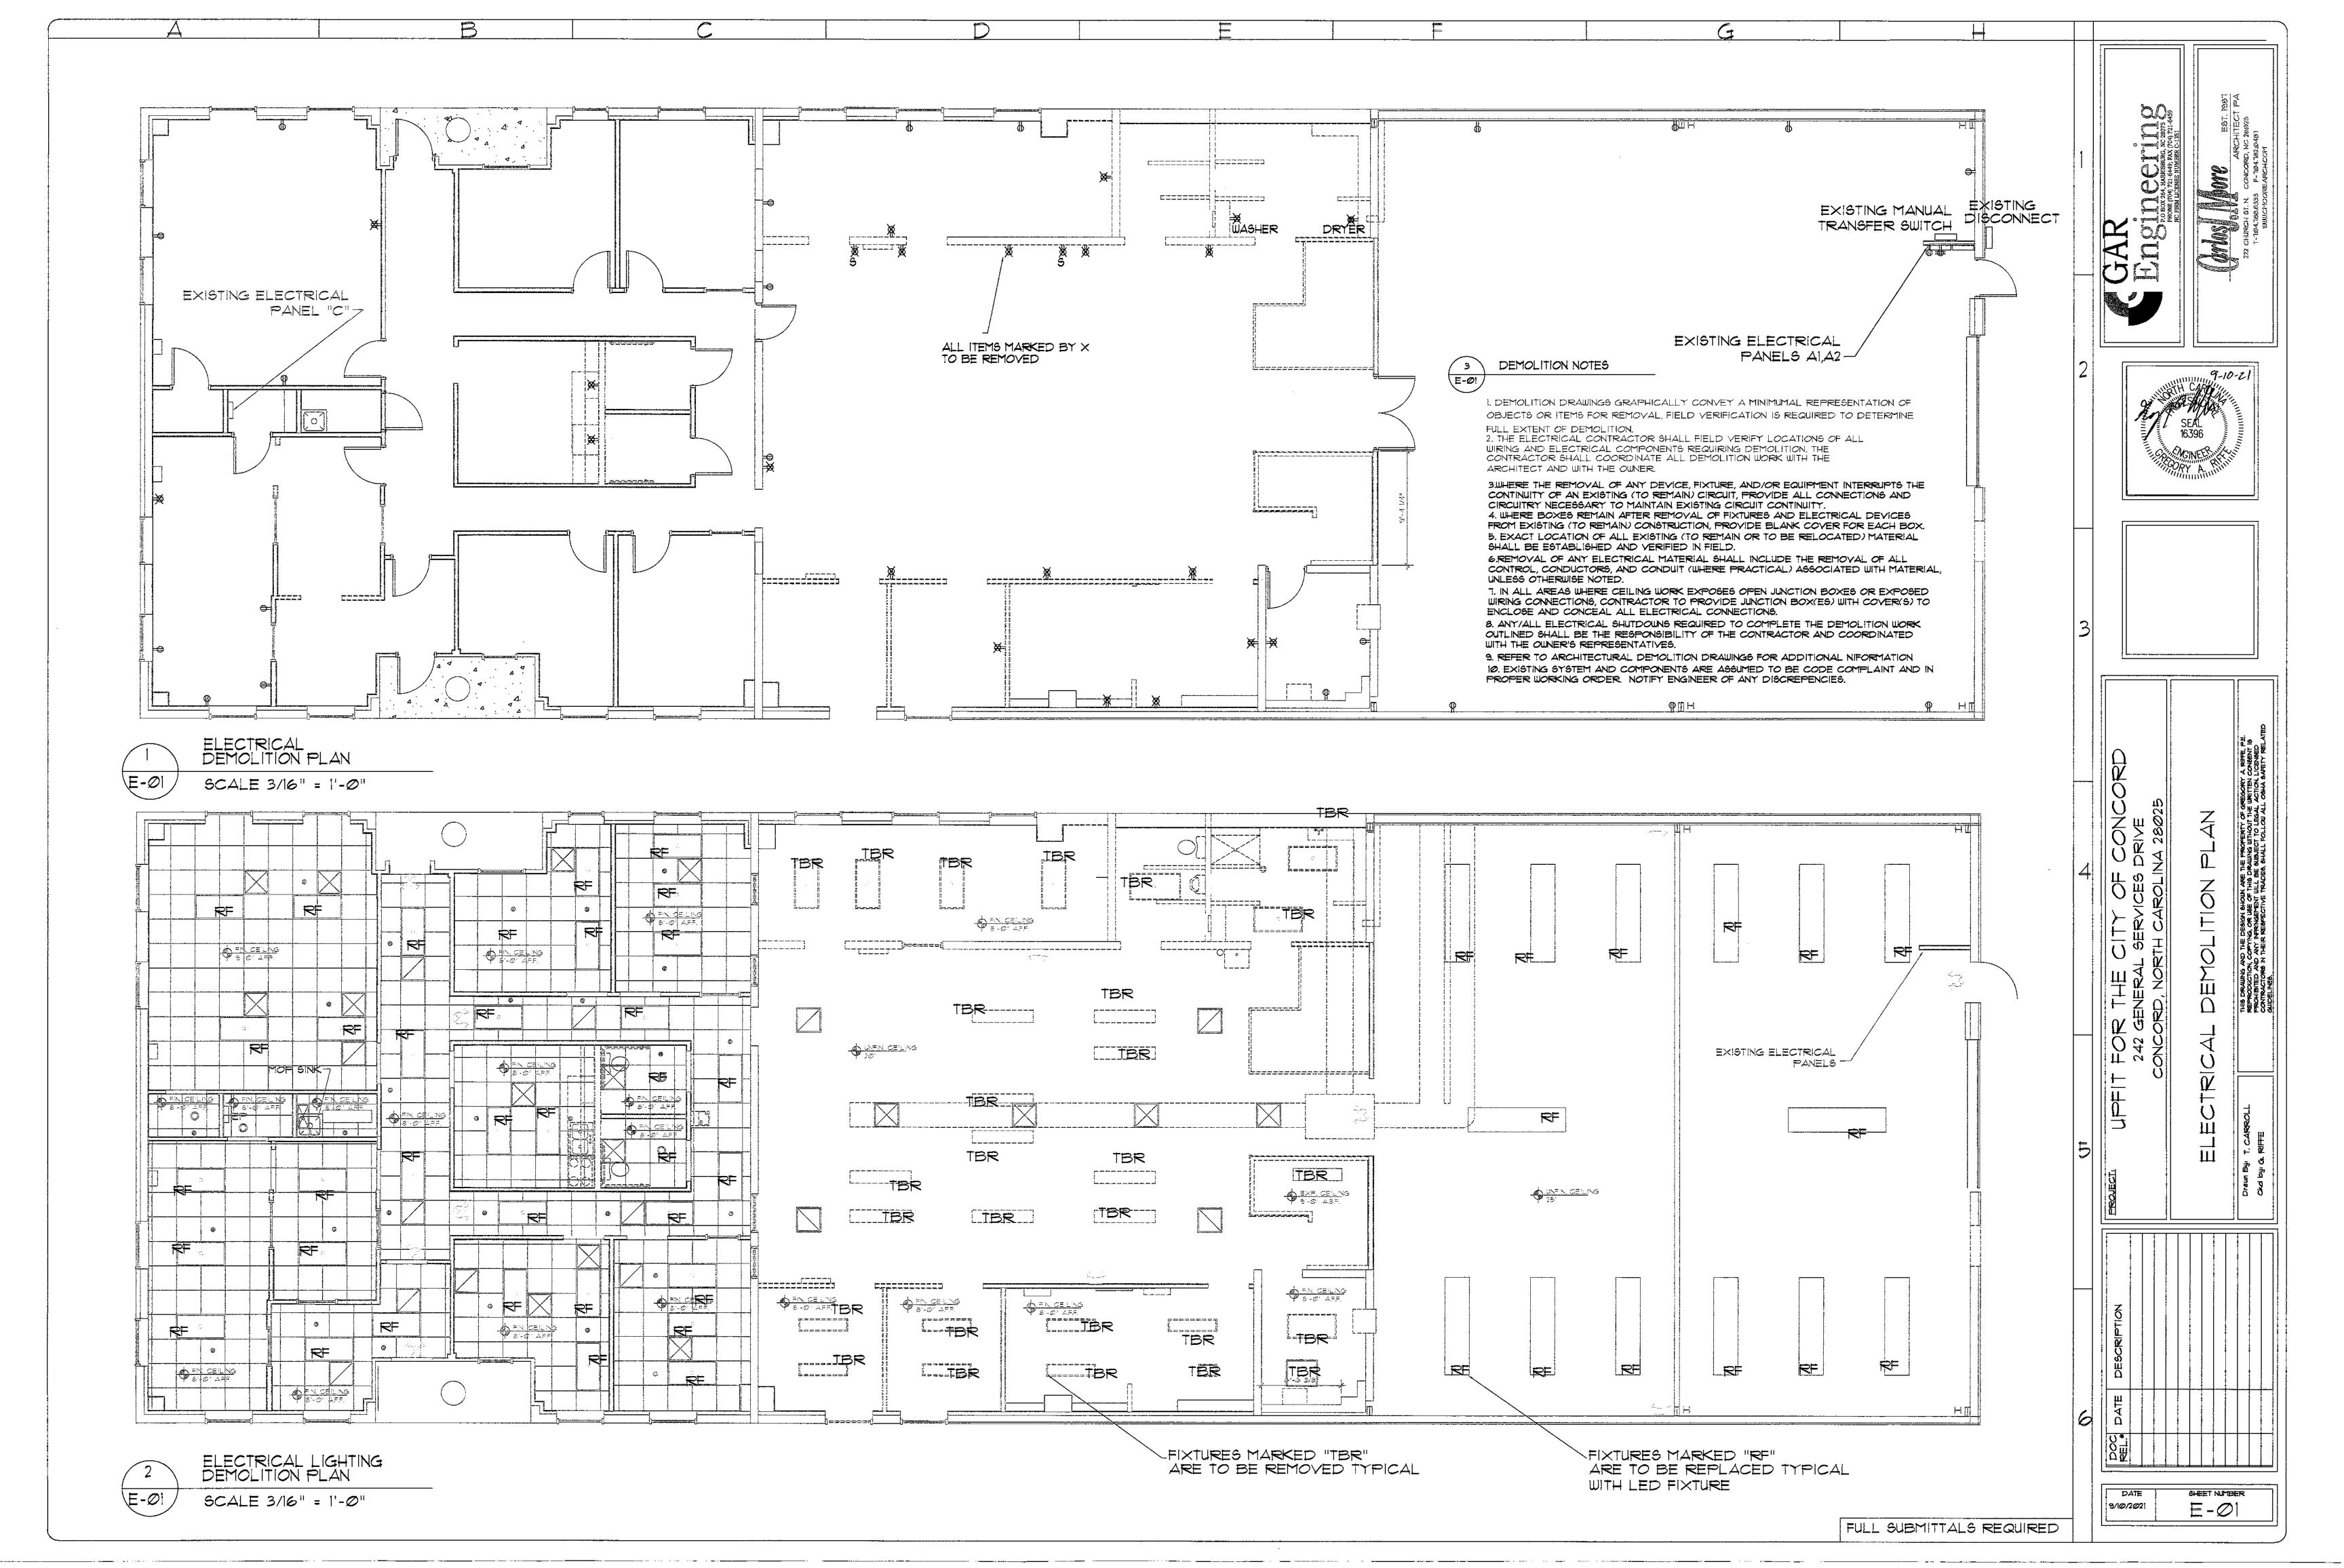

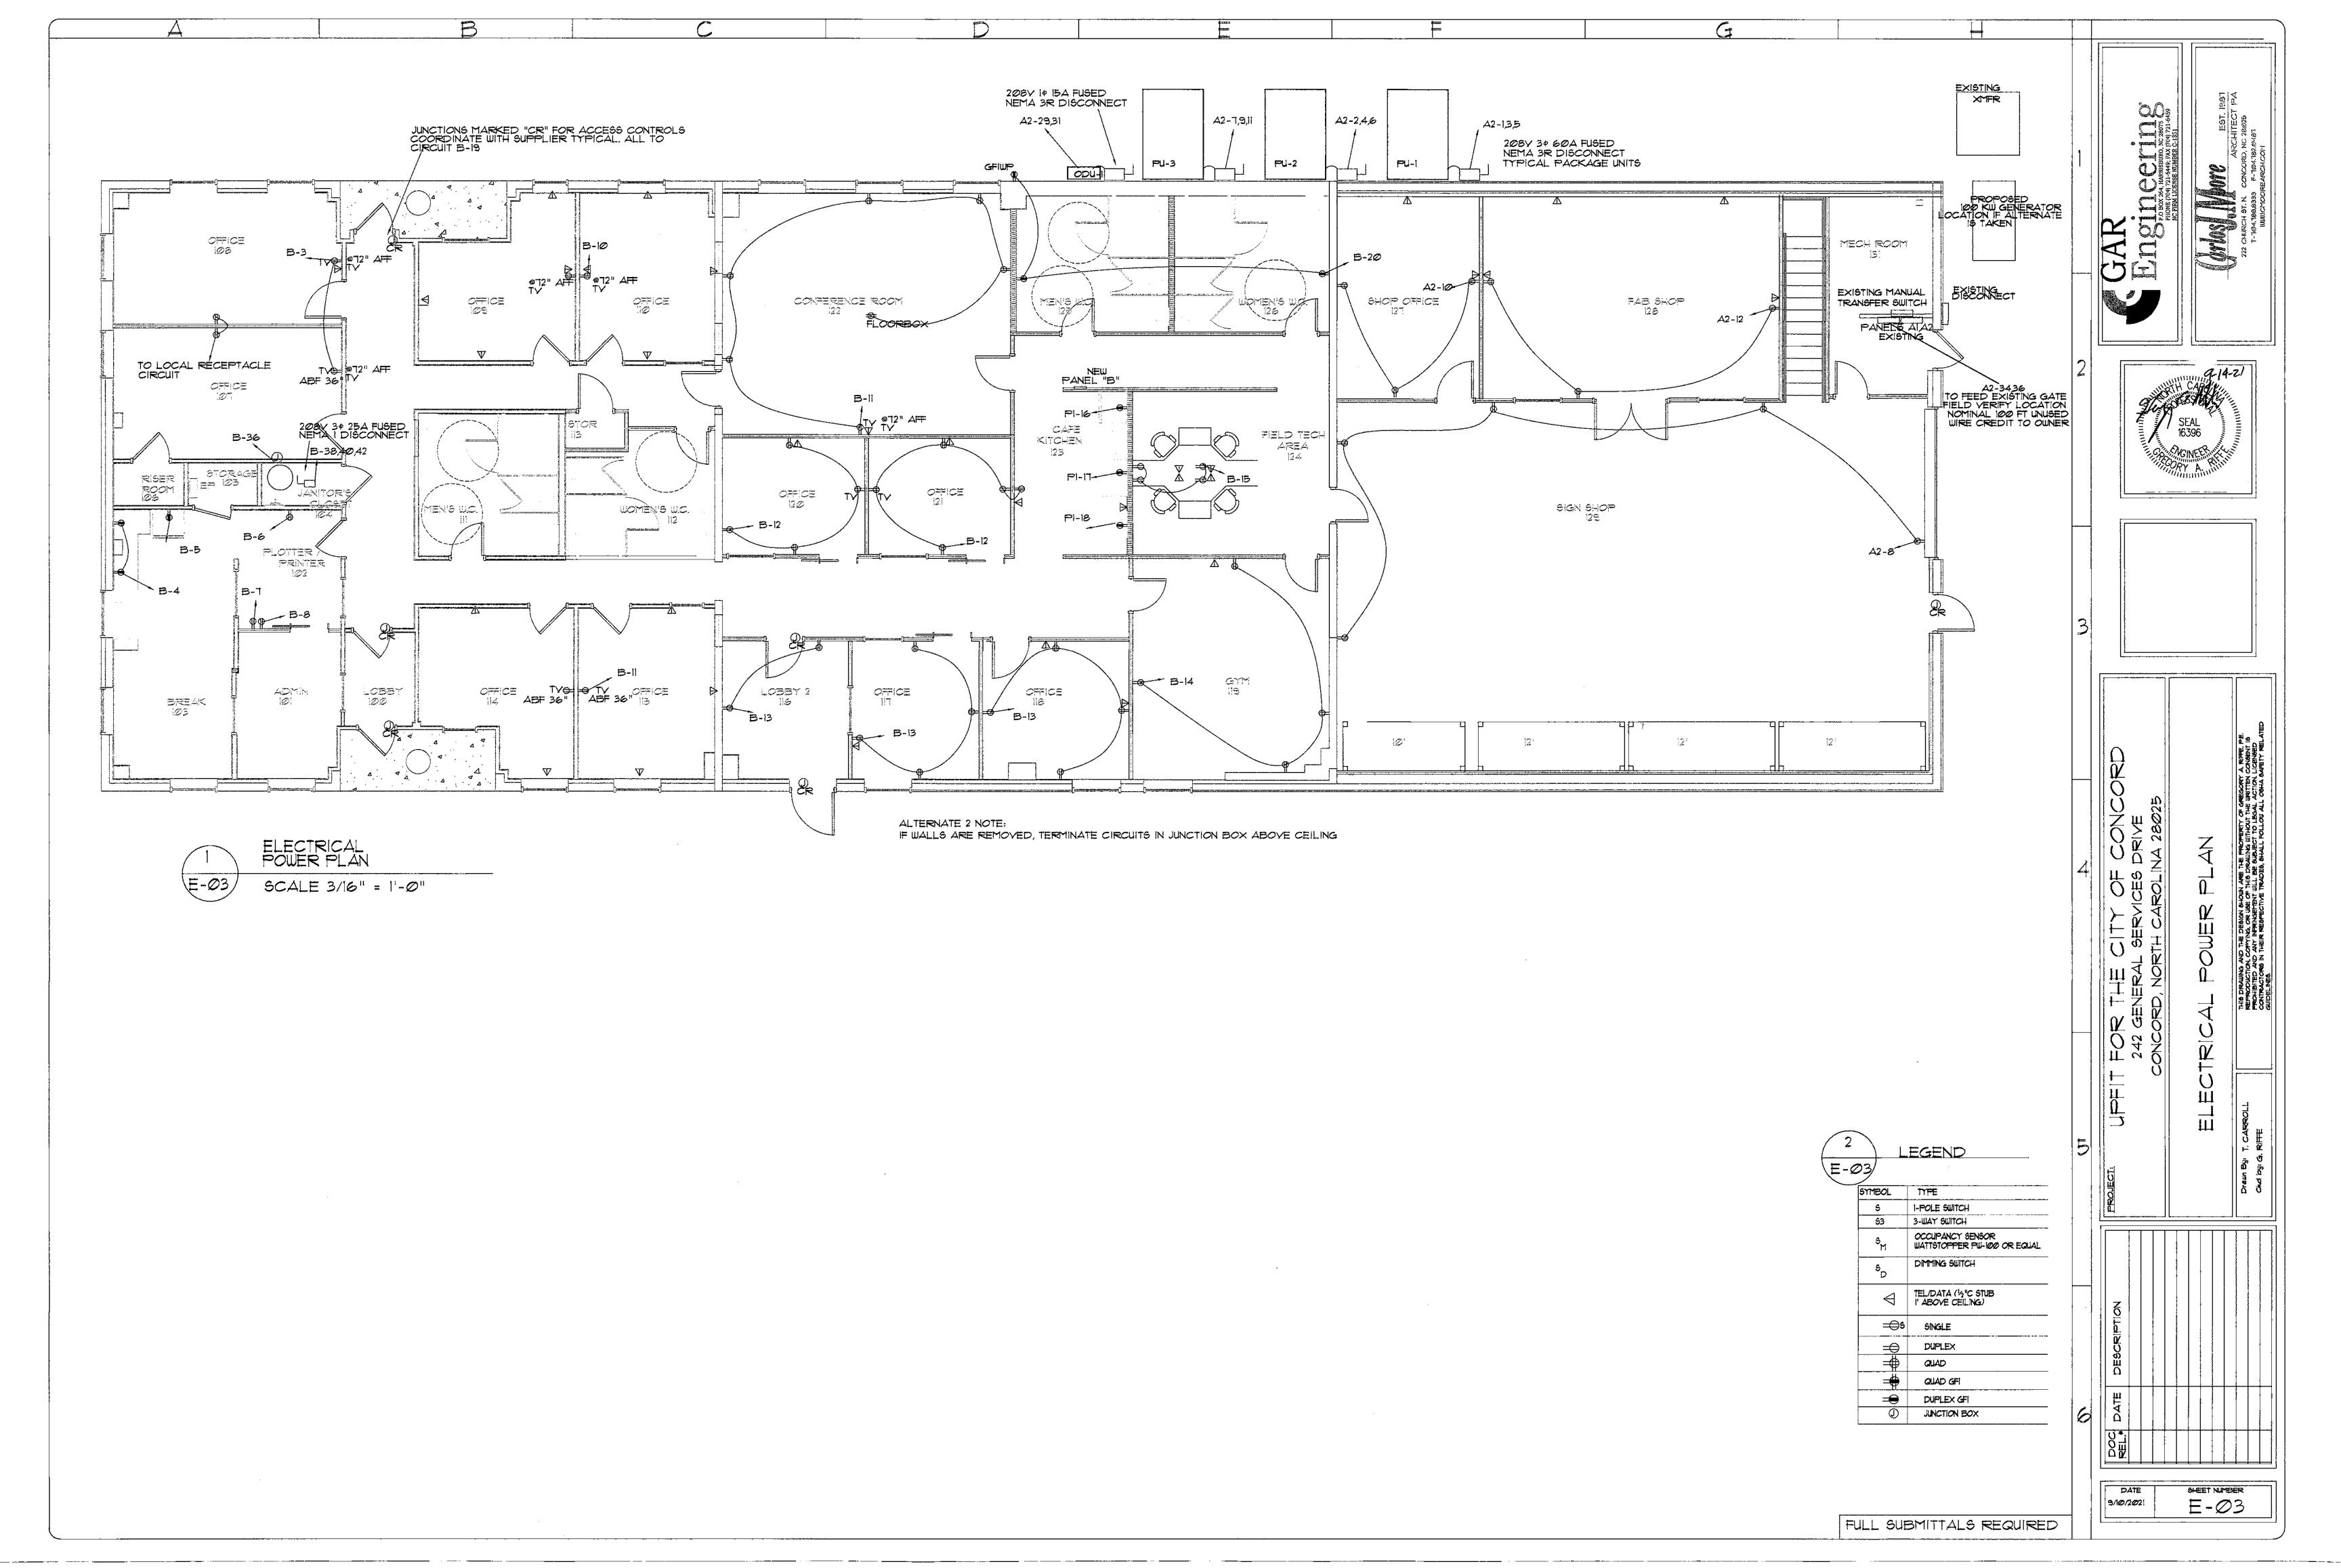

TOTAL VC-250 VICTAULIC V2708 5.6 VERIFY 0 1/2 PENDENT VC-250 VICTAULIC VERIFY 1/2 155 UPRIGHT 0 DRY SIDEWALL VC-250 VICTAULIC V3609 5.6 VERIFY \triangleleft 155 1/2

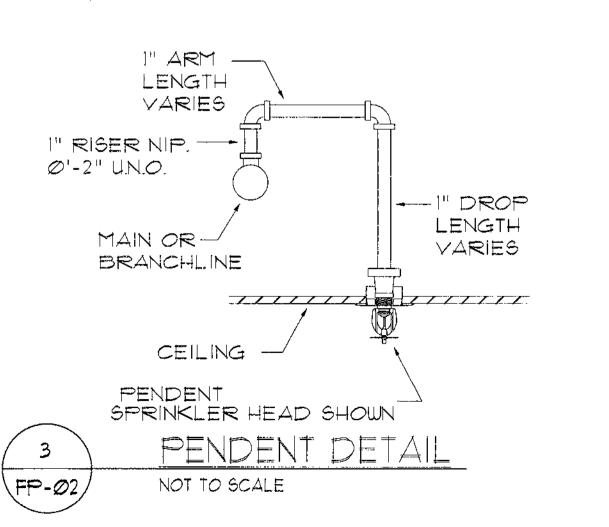

SPRINKLER SYSTEM NOTES

- 1. SPRINKLER SYSTEM SHALL BE INSTALLED IN ACCORDANCE WITH 2016 NFPA 13 AND
- ALL STATE AND LOCAL CODES.


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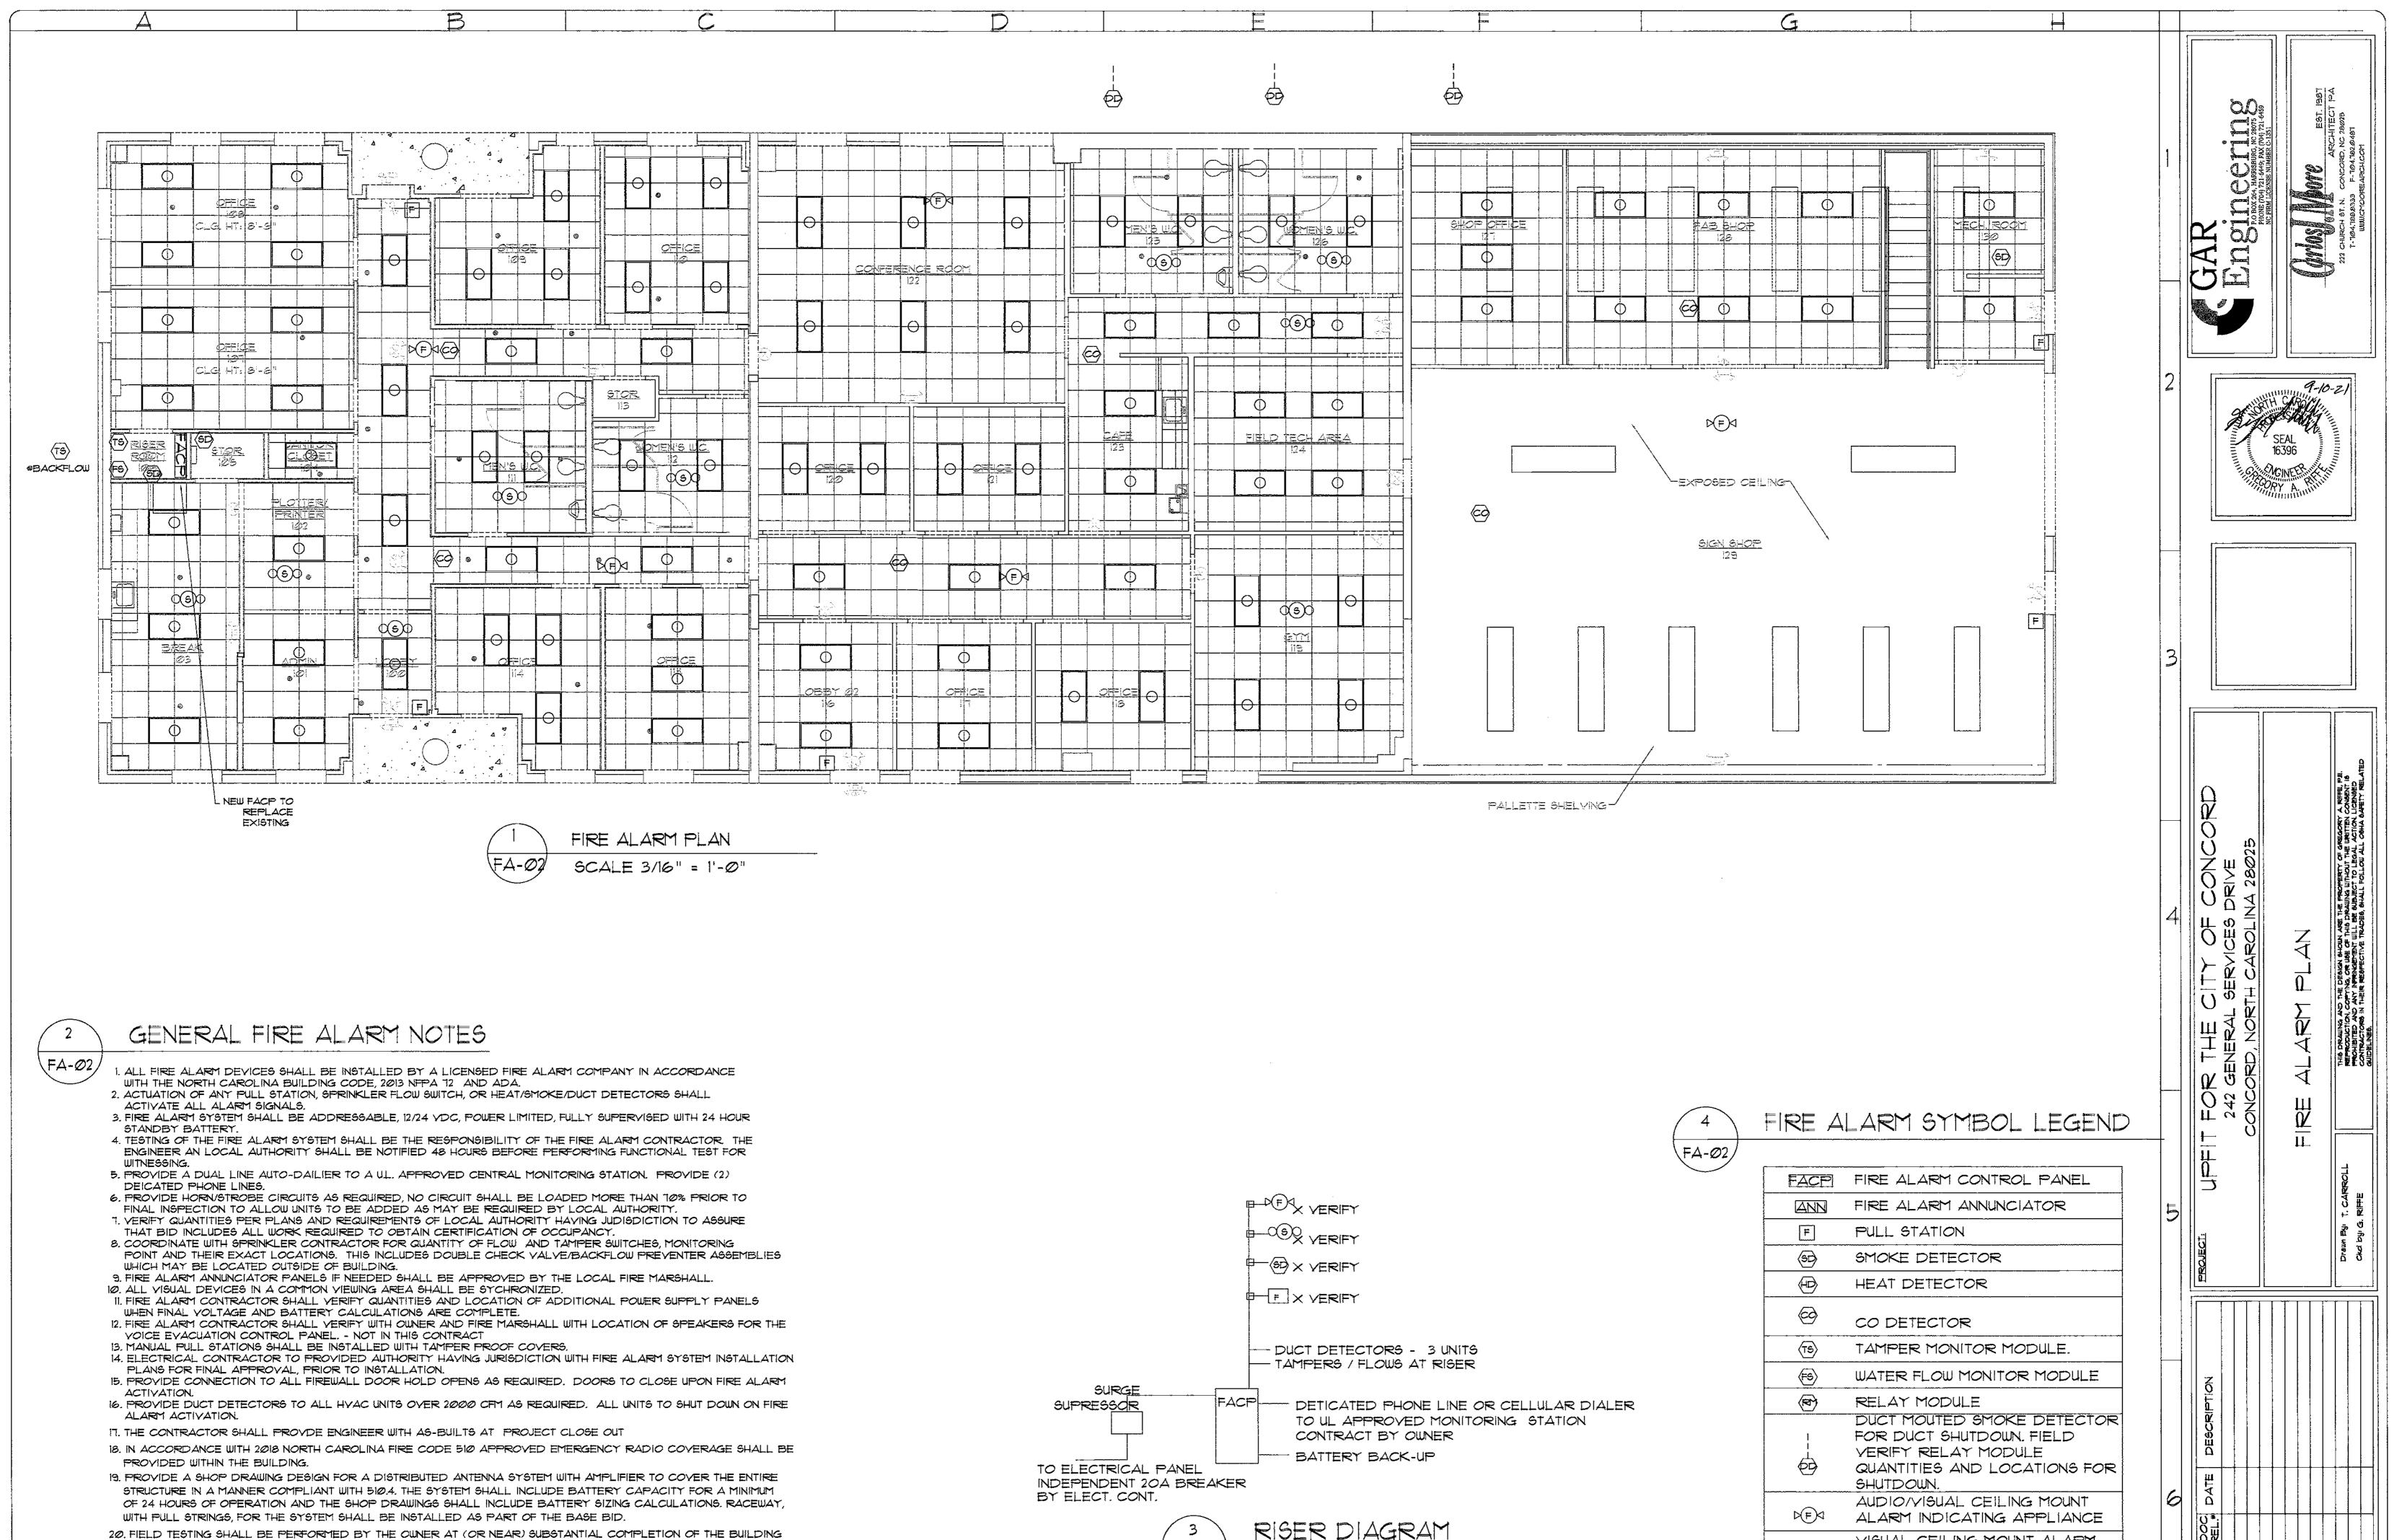
- 2. LIGHT HAZARD AREAS SHALL BE I GFM OVER MOST HYDRAULICALLY REMOTE 1500 SQ FT WITH HOSE STREAMS
- ORD. HAZARD GRP IAREAS SHALL BE JEGPM OVER MOST HYDRAULICALLY REMOTE 1500 SQ FT WITH HOSE STREAMS
- 3. TOTAL SYSTEM AREA: TOTAL AREA APPROX 1,650 SQ FT
- 4. PIPING 11/2" AND LARGER SHALL BE BLACK STEEL SCHEDULE 10 JOINED WITH GROOVED CAST IRON FITTINGS.
- 5. PIPING 14" AND SMALLER SHALL BE BLACK STEEL SCHEDULE 40 JOINED WITH
- CAST IRON FITTINGS.
- 6. HANGERS SHALL BE INSTALLED IN ACCORDANCE WITH NFPA 13.
- 1. ALL WORK SHALL BE PERFORMED BY A CONTRACTOR LICENSED IN THE STATE OF NORTH CAROLINA.
- 8. ALL SUBMITTALS SHALL BE PROVIDED TO THE ENGINEER FOR APPROVAL
- 9. UPON COMPLETION ALL "AS-BUILT" DRAWINGS AND MATERIAL AND TEST CERTIFICATES SHALL BE PROVIDED TO THE ENGINEER FOR PROJECT COMPLETION.
- 10. DRAWINGS ARE SCHEMATIC IN NATURE. SPRINKLER CONTRACTOR SHALL PROVIDE SYSTEM DESIGN FOR FULLY OPERATIVE SYSTEM INCLUDING AND COMPONENTS AND TRIM, AND IN COMPLIANCE WITH ALL APPLICABLE CODES

FULL SUBMITTALS REQUIRED

Y OT AROLIN

DATE SHEET NUMBER FP-Ø2 9/10/2021



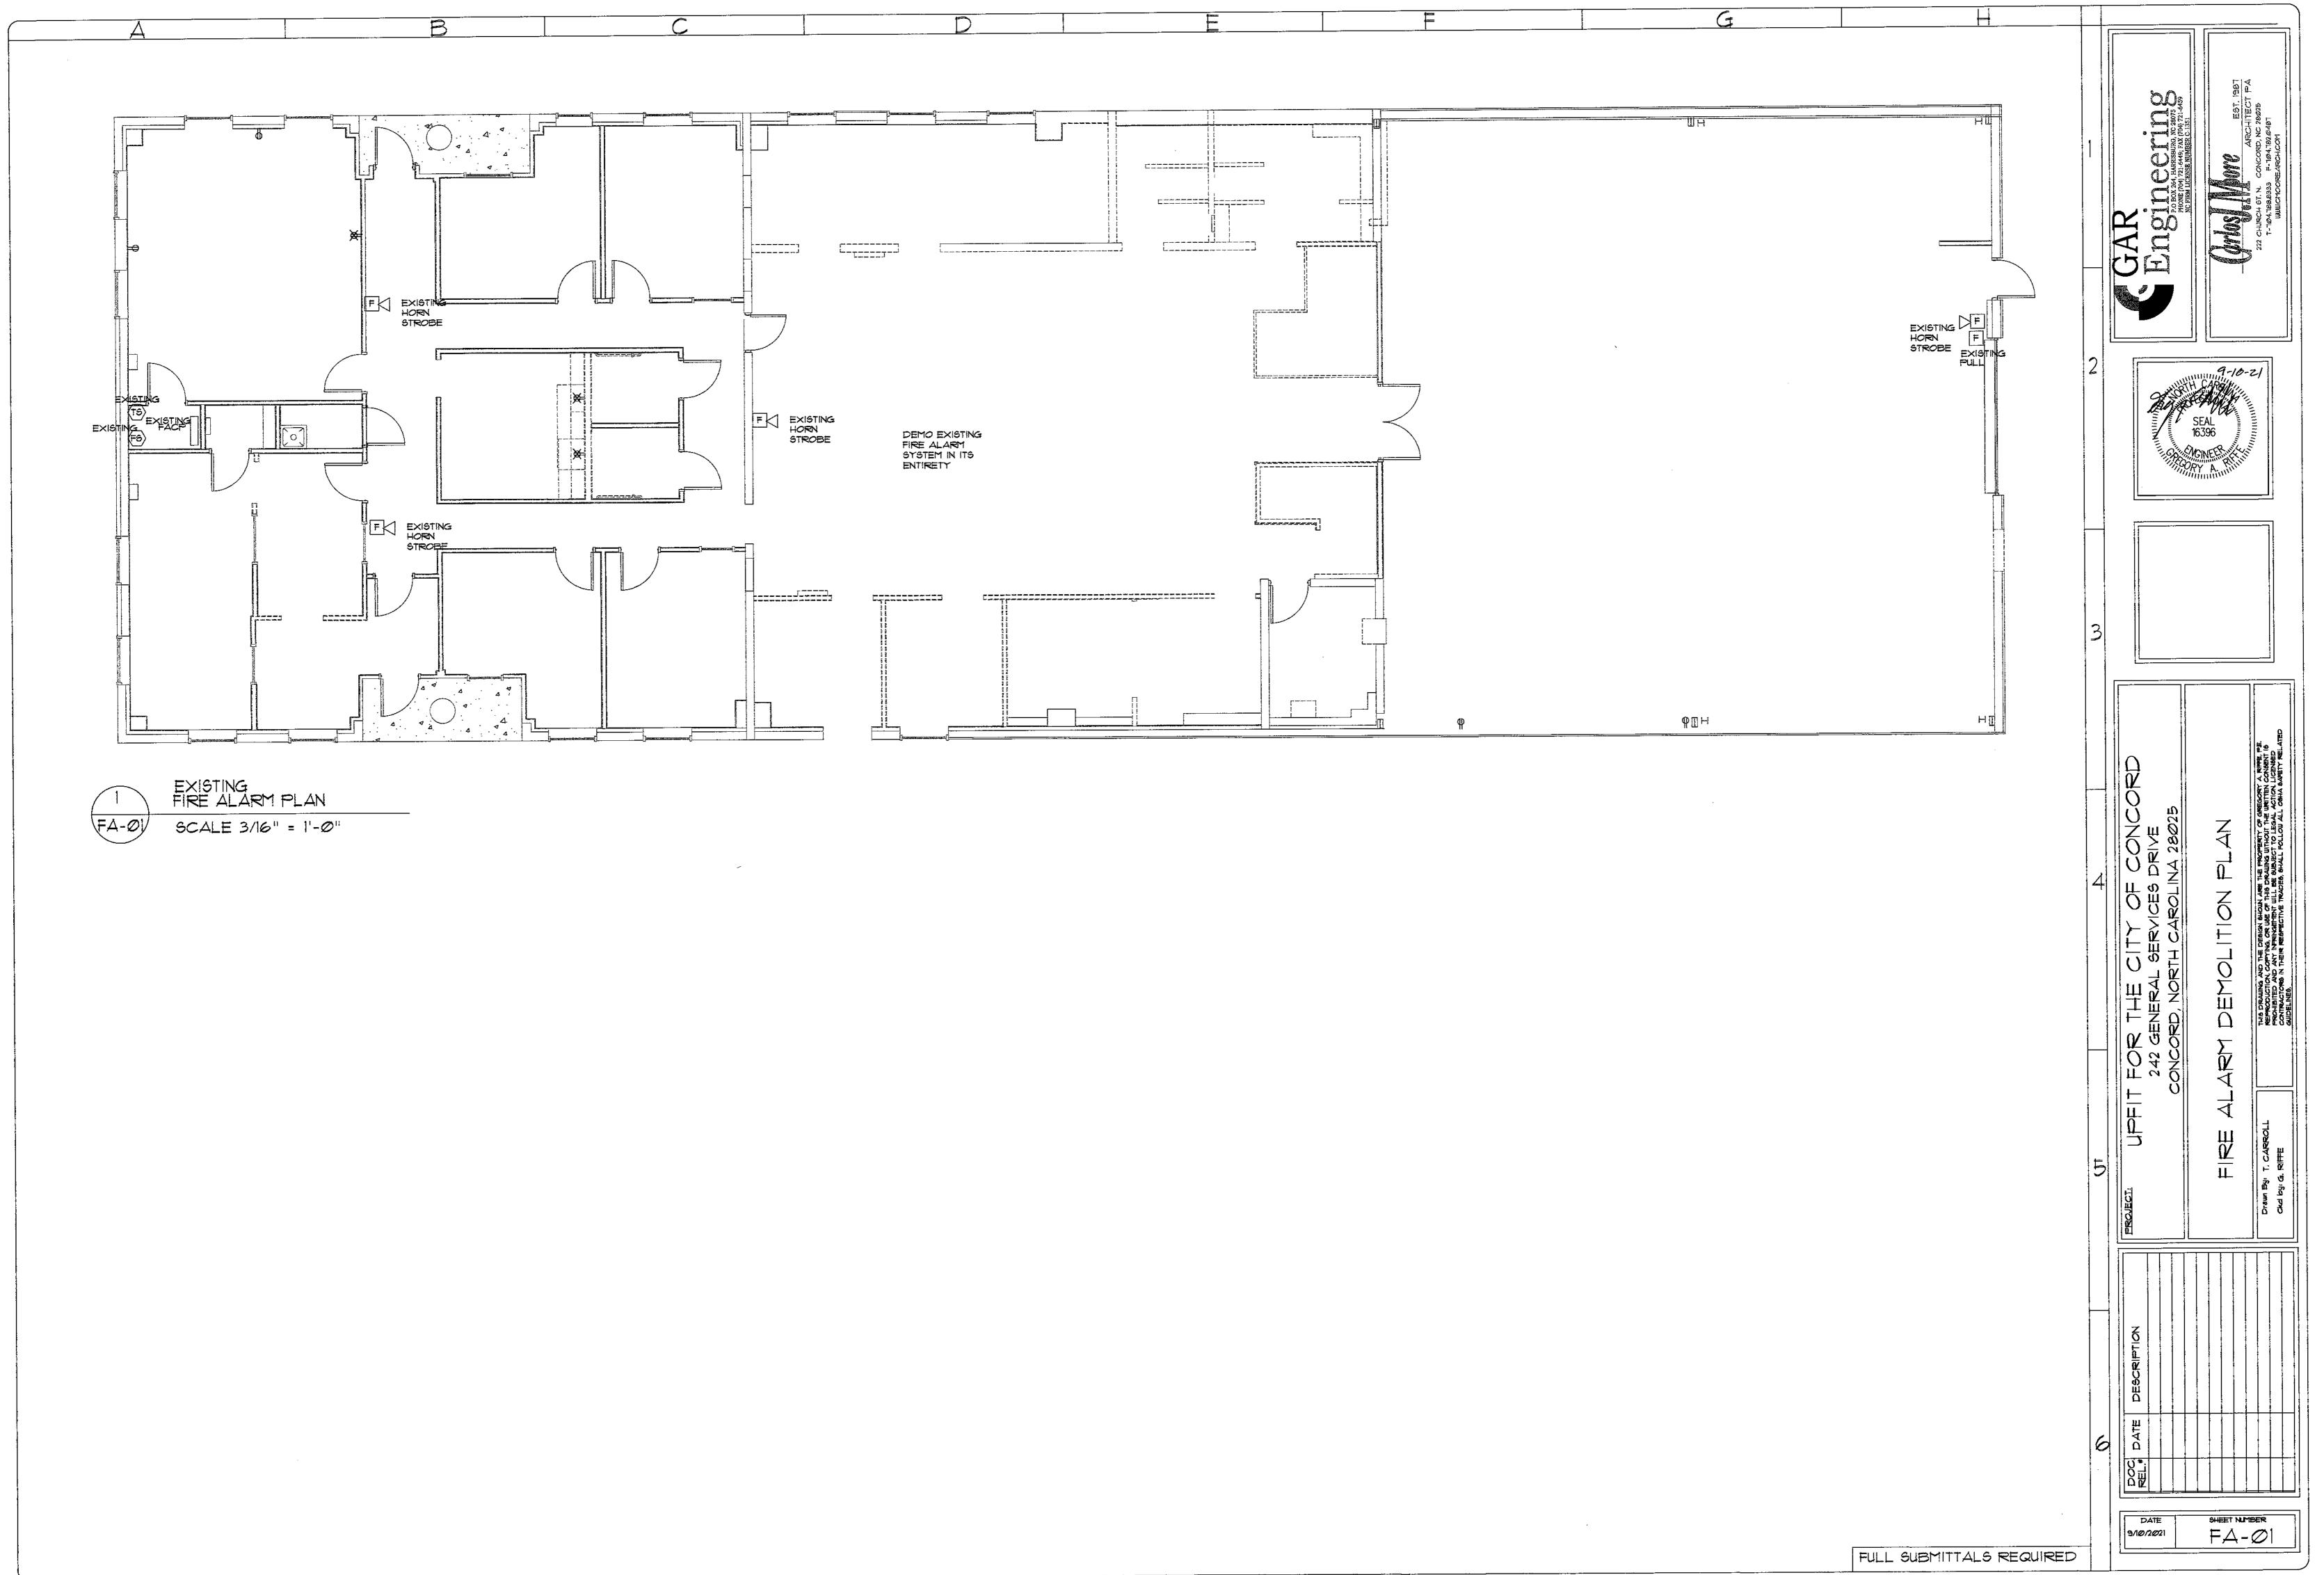

FA-Ø2

PER 2018 NCFC 51053, AND TEST RECORDS SHALL BE PROVIDED TO FIRE MAHAL FOR ACCEPTANCE.

SHALL BE PROVIDED TO THE FIRE MARSHAL FOR ACCEPTABLE.

21. IF COVERAGE IS NOT DEEMED TO BE ACCEPTABLE BY THE FIRE MARSHAL THEN THE AMPLIFIER, CONDUCTORS, AND ALL

ADDITIONAL REQUIRED SYSTEM PARTS SHALL BE PROVIDED IN ACCORDANCE WITH THE SHOP DRAWINGS, AND SECTION 5105,

INCLUDING OBTAINING A PERMIT PER 510.3. THE SYSTEM SHALL BE RETESTED BY THE OWNER PER 510.5.3, AND TEST RECORDS

FULL SUBMITTALS REQUIRED

DATE

9/10/2021

SHEET NUMBER

FA-Ø2

VISUAL CEILING MOUNT ALARM

INDICATING APPLIANCE